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# Planning Commission Staff Report

TO: PLANNING COMMISSION / DESIGN REVIEW BOARD

FROM: STEPHANIE BUBENHEIM, PLANNER II

(480) 503-6625, STEPHANIE.BUBENHEIM@GILBERTAZ.GOV

THROUGH: CATHERINE LORBEER, AICP, PRINCIPAL PLANNER

(480) 503-6016, CATHERINE, LORBEER @ GILBERTAZ, GOV

**MEETING DATE: NOVEMBER 6, 2019** 

SUBJECT: DR19-133, GILBERT SPECTRUM BUILDING 5

**STRATEGIC INITIATIVE:** Exceptional Built Environment

To allow for development of a large business park.

#### RECOMMENDED MOTION

Approve the Findings of Fact and approve DR19-133, Gilbert Spectrum Building 5: site plan, landscape, grading and drainage, elevations, floor plans, lighting, colors and materials for approx. 8.46 acres, generally located west of the southwest corner of McQueen and Elliot Roads and zoned Light Industrial (LI) with a Planned Area Development (PAD) overlay.

<u>APPLICANT</u> OWNER

Company: SunCap Property Group Company: SunCap Gilbert LLC

Name: Dylan Tomlin Name: Dylan Tomlin

Address: 1125 17<sup>th</sup> Street Ste 800 Address: 6101 Carnegie Blvd. Ste. 180

Denver, CO 80202 Charlotte, NC 28209

Phone: (720) 668-4983 Phone: (720) 668-4983

Email: dtomlin@suncappg.com Email: dtomlin@suncappg.com

# BACKGROUND/DISCUSSION History

Date	Description
August 12, 1986	The Town adopted Ordinance No. 470 (Z86-12) amending the Town zoning maps by changing the zoning classification from Agricultural (AG) to Planned Area Development (PAD).
September 29, 1987	Town Council adopted Ordinance No. 536 (Z87-12) amending the Town zoning map by changing the zoning classification from AG to Garden Industry (I-1) with a Planned Area Development (PAD) overlay.
March 28, 2000	Town Council adopted Ordinance No. 1257 (Z00-66) amending approx. 14 gross acres of the Fortune/Spectrum Astro PAD from Neighborhood Commercial (C-1) to Garden Industrial (I-1).
May 11, 2000	Design Review Board approved DR00-14 Spectrum Astro site plan and elevations.
May 17, 2005	Design Review Board approved DR00-14 Spectrum Astro revised site plan and Buildings A1 and A2.
March 13, 2008	Design Review Board approved DR07-155 Gilbert Spectrum conceptual site plan for 80 acres, and detailed plans for 38 acres and 458,842 square feet of Light Industrial development.
May 28, 2008	Town Council approved Resolution No. 2884 (GP08-07), a minor General Plan amendment to change the General Plan land use classification from Light Industrial (LI) to Community Commercial (CC), and Ordinance No. 2157 (Z08-02) change the zoning designation on an approx. 13.7 acres site from Light Industrial (LI) with a PAD overlay to Community Commercial (CC) for Gilbert Spectrum.
March 13, 2008	Design Review approved DR07-155 Conceptual Overall Site Plan, Lots 1 and 2 Site Plan/ Landscape Plan/ Grading and Drainage/ Elevations/ Floor Plans/ Lighting/ Colors and Materials for Gilbert Spectrum. Approval expired.
February 1, 2012	Town Council approved Resolution No. 3111, a Minor General Plan Amendment changing 4.68 acres of Community Commercial (CC) to Light Industrial (LI) and rezoning Ordinance No. 2362 (Z12-01) from Community Commercial (CC) to Light Industrial (LI) all with a PAD overlay.
April 9, 2015	Design Review Board approved DR15-04 and DR15-08 Overall Site Plan and Phase 1 improvements for Gilbert Spectrum and Master Sign Program. A portion of Phase 1 Improvements were installed but Building 1 was not constructed.
June 9, 2016	Design Review Board approved DR16-15 Revised Master Site Plan for Gilbert Spectrum and Building 7 design package.
September 5, 2018	Planning Commission approved DR18-113 revised Master Site Plan for Gilbert Spectrum and Building 1 design package.

June 12, 2019	Administrative approval for the location of Building 5 was
	approved and Building 6 was removed from the master site plan.
October 2, 2019	Planning Commission reviewed DR19-133 as a study session item.

#### Overview

This submittal DR package is for Building 5 of Gilbert Spectrum located along Elliot Road at the northwest corner of the master site plan. Building 5 will be a 2-story 120,362 sq. ft. office building to expand the Northrup Grumman facility campus; the user currently employs Building 7 and the industrial building directly west of Building 7.

Gilbert Spectrum Business Park, located at the southwest corner of McQueen and Elliot Roads, is a  $\pm 63.37$  acre project being developed by SunCap Property Group, servicing prospective employment tenants wishing to locate in Gilbert. Gilbert Spectrum Master Site Plan conforms to the General Plan by providing buildings suitable for uses that are permitted within the existing zoning districts. The overall larger project is planned to provide approx. 754,000 square feet of light industrial and office uses.

Gilbert Spectrum Business Park is being positioned to capture higher end users looking to locate in a master planned and fully improved environment. The character and composition of the business park will be consistent with other business parks in the region, complete with landscaping and curb appeal, and creating an environment conducive to the attraction and retention of Fortune 500 companies.

Currently Building 7, Building 1 and some Phase 1 improvements including parts of the Master Sign Plan have been constructed. Two main vehicular access points to the business park are provided, one from Elliot Road and the other from McQueen Road. Each main access drive provides a promenade experience through the use of symmetrical gabion walls and corten steel monument signage on both sides of the entry, lush landscape with palm tree accents and pedestrian sidewalks set back from the drive aisle curbs. The Phase 1 Tract A development at the Palo Verde Street main entry drive has been completed along with project signage. The same landscape theme and signage was installed at the intersection of McQueen and Elliot Roads.

**Surrounding Land Use & Zoning Designations:** 

	<b>Existing Land Use</b>	<b>Existing Zoning</b>	<b>Existing Use</b>
	Classification		
North	Light Industrial and	Light Industrial (LI) PAD	Elliot Road then Sunrise
	Community	and Community	Business Park and vacant
	Commercial	Commercial (CC) PAD	land
South	Light Industrial	Light Industrial (LI) PAD	Building 7 and vacant Gilbert
			Spectrum master site plan
			property
East	Community	Community Commercial	Vacant Gilbert Spectrum
	Commercial	(CC) PAD	master site plan property
West	Light Industrial	Light Industrial (LI) PAD	Northrup Grumman Building
Site	Light Industrial	Light Industrial (LI) PAD	Vacant land

**Project Data Table** 

Site Development Regulations	Required per LDC and Ordinance No. 2362 Light Industrial PAD	Proposed Building 5
Maximum Building Size	N/A	120,362 SF
Maximum Building Height (ft.)/(Stories)	55'/3 story	41' 6"/2 Story
Minimum Building Setback (ft.)		
Front	30'	91'
Side (Employment)	0'	135' 6"
Side (Commercial)	15'	146'
Rear (Employment)	0'	285'0'
Minimum Required Perimeter		
Landscape Area (ft.)		
Front	25'	25'
Side (Employment)	5'	5'
Side (Commercial)	15'	0', Internal to the master site plan
Rear (Employment)	5'	0', Internal to the master site plan
Landscaping (% of net lot area)	15%	40%
Parking Spaces	482 Required	603 provided

#### **DISCUSSION**

Building 5 improvements include a 2-story building and surrounding parking area, an additional full motion driveway entrance along Elliot Road with a right-turn deceleration lane, a right-turn deceleration lane along McQueen Road, two Gilbert Spectrum monument signs, and improvements to the north retention basin of the park and surrounding parking area. The master site plan was recently revised to combine the square footage of Building 5 and 6 into one 2-story building (Building 5).

Building 5 is positioned along Elliot Road frontage with the majority of parking spaces located between Buildings 5 and 7. A sidewalk will be installed connecting Building 5 and 7 to provide employees ease of access to the various buildings within the business park; this has been relocated to the west side of the parking lot. An employee amenity area is shown on the south side of the building. Vehicular access will be provided to the west connecting the site with the existing signalized entrance into Northrup Grumman; a cross access agreement has been provided between the two property owners. A full motion access to the east of Building 5 and drive aisle will be installed that will connect to the drive aisle north of Building 1. The north retention basin of Gilbert Spectrum was partially installed with Building 1 to accommodate storm drainage. This phase will further enlarge the retention basin and improve it with landscaping and a decomposed granite pathway for employees to use as an amenity. This phase will also complete the perimeter parking spaces and landscape islands of Building 7 adjacent to the retention basin.

There is an existing jog in the right-of-way along Elliot Road that was intended in prior years to be a new driveway entrance. The applicant is requesting the Town vacate the right-of-way as the driveway entrance is no longer part of the master site plan. Staff has added a condition to modify the landscape setback in that area prior to construction document submittal to meet code requirements. If the right-of-way is vacated, the applicant may come back through administrative design review and modify the landscape area at that location on the appropriate sheets.

#### Landscape

The site landscape package includes improvements to Building 5 and the north retention basin of the master site plan, landscape percentage for this phase is 40%. The landscape palette and design along Elliot Road matches the landscape installed with Phase I improvements and Building 1, with clusters of the same plants in an organized fashion and the street theme tree Mondel Pines proposed. Trees consist of Desert Museum Palo Verde, Live Oak, Texas Mountain Laurel, and Date Palms. The landscape that will be installed within the retention basin is consistent with the plant palette used in the Gilbert Spectrum master site plan. Trees and shrubs are placed along the perimeter/sides of the retention basin. A decomposed granite (DG) trail will be provided at the top of the basin along three sides to provide an additional amenity to employees of businesses within nearby buildings to use.

#### **Grading and Drainage**

For Building 5, some retention is proposed along Elliot Road landscape frontage and the site is designed to flow to the retention basin southeast of Building 5, which will be used as a retention basin for the north portion of the business park. There is an existing basin at the southwest corner of the business park that receives storm water through a series of underground interconnecting pipes. The proposed grading and drainage plan generally meets the requirements of the Town of Gilbert's Engineering Division.

#### **Elevations, Floor Plan, Colors and Materials**

Building 5's color scheme is consistent with the Gilbert Spectrum color and materials used on Building's 1 & 7. The architecture of Building 5 mimics the architecture of Building 7 at the 2-story scale. The main body of the building will be concrete tilt panel painted "Whole Wheat" with accents of "Sand Dune" around windows at intervals, and "Roxy Brown" is used at recessed entrances. Stone veneer wing walls perpendicular to the horizontal plane of the building are placed at entrances to provide visual interest. Tenant entrances are recessed into the building to provide depth. Entrances are further accented through the use of metal panel awnings to provide shade.

#### Lighting

The lighting proposed for Building 5 consists of parking lot light poles and wall mounted lights and is consistent with the lighting of Buildings 1 and 7. The proposed wall sconces are mounted at 25' high and will require the Planning Commission/Design Review Board to meet the two additional findings of fact listed below:

a. The fixtures are used for the purpose of: accentuating architectural features of the building, accentuating signage, accentuating landscape or hardscape features, security or for service areas; and

b. The fixtures are located on building elevations that do not side onto property designated for residential use in the General Plan.

#### Signage

Two Gilbert Spectrum entry monument signs and one tenant monument sign are consistent with the Master Sign Plan and are included in this phase of development. Other signage is not included in this approval and must follow the Gilbert Spectrum Master Sign Plan DR15-08.

#### PLANNING COMMISSION STUDY SESSION COMMENTS

At the October 2<sup>nd</sup> Planning Commission (PC) study session, members of the commission provided the following comments:

- Commissioners discussed the importance of connecting the internal private drive to the existing drive aisle north of Building 1 at this phase.
  - o The connection between the two drive aisles is included in this phase.
- Commissioners discussed the proposed signage area and accenting entrances.
  - The entrances are accented with metal awnings and are recessed into the buildings. There are also flagstone wing walls perpendicular to the buildings horizontal plane to provide movement. An entrance on the southwest corner of the building has been revised to include a low wing wall and awning to accentuate the entrance further. The applicant feels the entrances provide adequate architectural enhancements.

#### **PUBLIC NOTIFICATION AND INPUT**

An official notice was posted in all the required public places within the Town and neighborhood notice was provided per the requirements of the Land Development Code (LDC) Article 5.205.

Staff has received no comment from the public.

#### STAFF RECOMMENDATION

Approve the Findings of Fact and approve DR19-133, Gilbert Spectrum Building 5: site plan, landscape, grading and drainage, elevations, floor plans, lighting, colors and materials for approximately 8.46 acres, generally located west of the southwest corner of McQueen and Elliot Roads and zoned Light Industrial (LI) with a Planned Area Development (PAD) overlay, subject to conditions:

- 1. Construction of the project shall conform to the exhibits approved by the Planning Commission at the November 6, 2019 public hearing.
- 2. The construction site plan documents shall incorporate the Standard Commercial and Industrial Site Plan Notes adopted by the Design Review Board on March 11, 2004.
- 3. Two entry monument signs and one tenant sign were reviewed for location along Elliot Road as part of the Gilbert Spectrum Master Sign Program (MSP) and may proceed through sign permitting. All building signage must follow the MSP or an Administrative

Design Review approval is required to amend the sign program before proceeding through sign permitting.

- 4. Prior to construction document (CD) submittal, the applicant shall provide Planning Staff with revised Site, Landscape, and Grading and Drainage plans to reflect the property line jog to meet landscape setback requirements along Elliot Road.
- 5. Upon completion of a signed Resolution for vacation of Right-of-Way along Elliott Road for a prior driveway entrance, the applicant may submit an Administrative Design Review to modify the landscape area and parking stalls in that portion of the project.
- 6. Parking screen wall along west property line north of drive aisle access shall be removed.
- 7. Recorded documentation of cross access agreements must be provided and shown on the Final Plat.

Respectfully submitted,

Stephanie Bubenheim Planner II

#### **Attachments and Enclosures:**

- 1) Finding of Fact
- 2) Notice of Public Hearing
- 3) Aerial Photo
- 4) Master Site Plan
- 5) Site Plan
- 6) Landscape
- 7) Grading and Drainage
- 8) Colors and Materials
- 9) Elevations
- 10) Floor Plans
- 11) Lighting

# FINDINGS OF FACT DR19-133, Gilbert Spectrum Building 5

- 1. The project as conditioned is consistent with the applicable Design Guidelines;
- 2. The project conforms to the General Plan, and specifically to the Land Use, Community Design, and Environmental Planning Elements;
- 3. The project is consistent with all applicable provisions of the Zoning Code;
- 4. The project is compatible with adjacent and nearby development; and
- 5. The project design provides for safe and efficient provisions of public services.
- 6. The fixtures are used for the purpose of: accentuating architectural features of the building, accentuating signage, accentuating landscape or hardscape features, security or for service areas; and
- 7. The fixtures are located on building elevations that do not side onto property designated for residential use in the General Plan

# DR19-133 Gilbert Spectrum Building 5 Notice of Public Hearing November 6, 2019

#### PLANNING COMMISSION DATE:

Monday, November 6, 2019\* TIME: 6:00 PM

LOCATION: Gilbert Municipal Center **Council Chambers** 50 E. Civic Center Drive

Gilbert, Arizona 85296


\* Call Planning Department to verify date and time: (480) 503-6625

\* The application is available for public review at the Town of Gilbert Development Services division Monday - Thursday 7 a.m. - 6 p.m. Staff reports are available prior to the meeting at https://www.gilbertaz.gov/departments/development-services/planning/planning-commission and http://www.gilbertaz.gov/departments/clerk-s-office/boards-commissions/town-council

#### **REQUESTED ACTION:**

DR19-133 GILBERT SPECTRUM BUILDING 5: Site plan, landscape, grading and drainage, elevations, floor plans, lighting, colors and materials, for approximately 8.46 acres, generally located west of the southwest corner of McQueen and Elliot Roads, and zoned Light Industrial (LI) with a Planned Area Development (PAD) overlay.

#### **SITE LOCATION:**

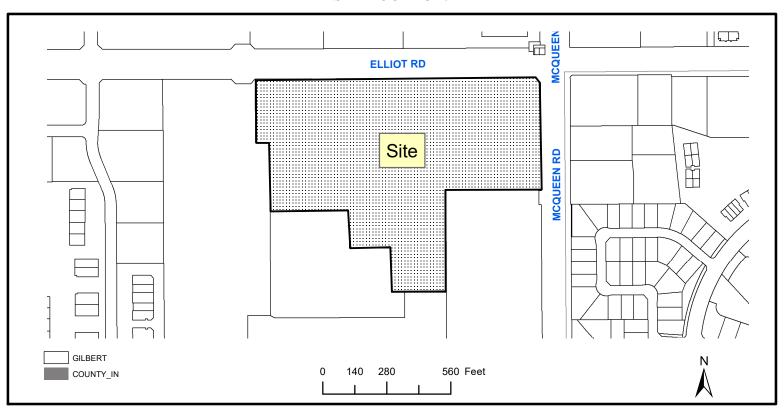

APPLICANT: Suncap Property Group

CONTACT: Dylan Tomlin

ADDRESS: 1125 17th Street, Suite 800

Denver, Colorado 80202

TELEPHONE: (720) 668-4983 E-MAIL: dtomlin@suncappg.com

# **EXHIBIT 3: PARCEL MAP**


GILBERT SPECTRUM BLDG. #5 8.23.19




DR19-133 Gilbert Spectrum Building 5 Attachment 3: Aerial Photo November 6, 2019





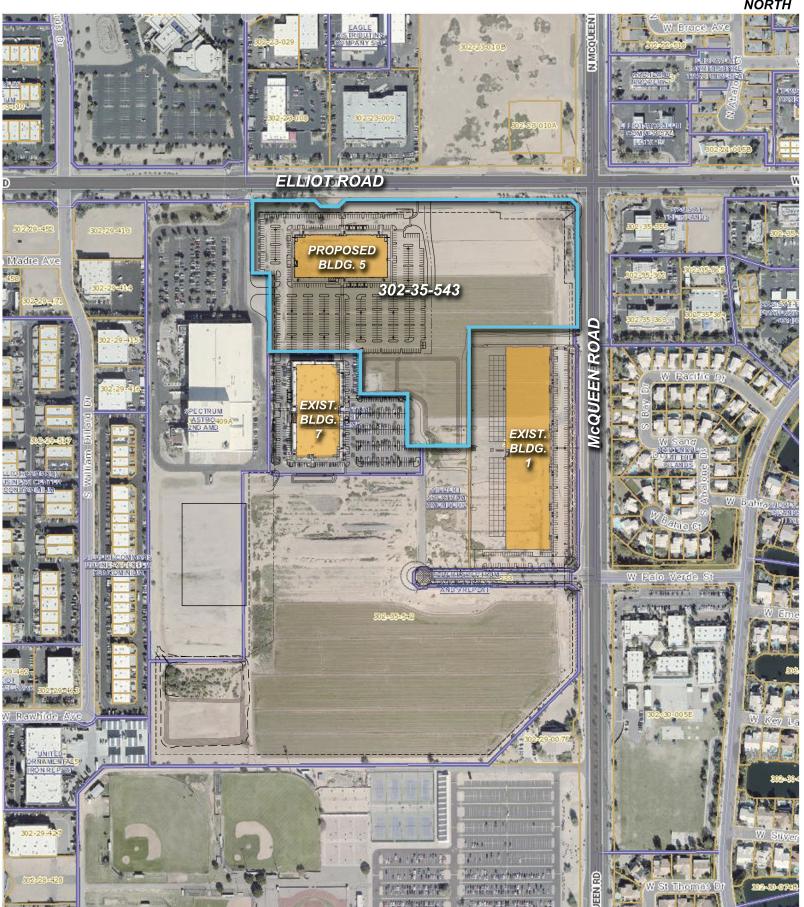

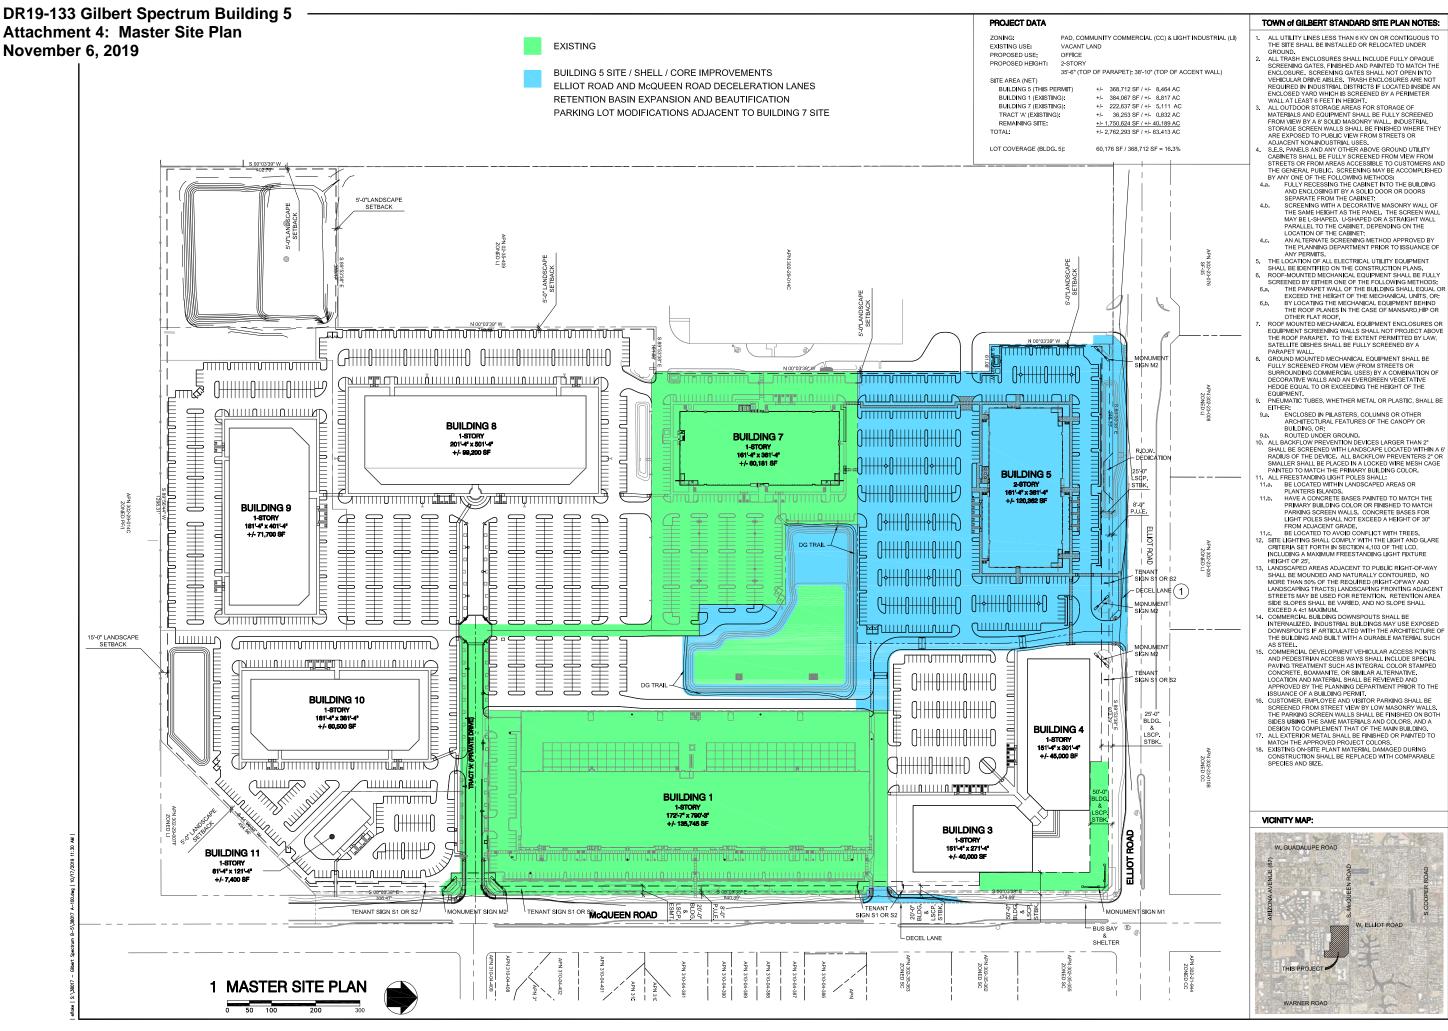

#### TOWN of GILBERT STANDARD SITE PLAN NOTES:

- ALL UTILITY LINES LESS THAN 6 KV ON OR CONTIGUOUS TO THE SITE SHALL BE INSTALLED OR RELOCATED UNDER

- ROOF MOUNTED MECHANICAL EQUIPMENT ENCLOSURES OF EQUIPMENT SCREENING WALLS SHALL NOT PROJECT ABOV THE ROOF PARAPET. TO THE EXTENT PERMITTED BY LAW, SATELLITE DISHES SHALL BE FULLY SCREENED BY A
- FULLY SCREENED FROM VIEW (FROM STREETS OR SURROUNDING COMMERCIAL USES) BY A COMBINATION OF DECORATIVE WALLS AND AN EVERGREEN VEGETATIVE HEDGE EQUAL TO OR EXCEEDING THE HEIGHT OF THE
- PNEUMATIC TUBES, WHETHER METAL OR PLASTIC, SHALL B

- ALL TRASH ENCLOSURES SHALL INCLUDE FULLY OPAQUE

- ROOF MOUNTED MECHANICAL FOUIPMENT ENCLOSURES O
- GROUND MOUNTED MECHANICAL FOURMENT SHALL BE

- 18. EXISTING ON-SITE PLANT MATERIAL DAMAGED DURING CONSTRUCTION SHALL BE REPLACED WITH COMPARABLE SPECIES AND SIZE.
- **BUILDING 5**
- **DESIGN REVIEW**

10.17.2019 ssue Date Scale: 1" = 40" Drawn By: EF REVISIONS

**GILBERT SPECTRUM** 

**⊌** SunCap

BALMER

**GRAYCOR** 

PROPERTY GROUP




DRAWING TITLE:

MASTER SITE PLAN

**EXHIBIT 4A** 

A-100

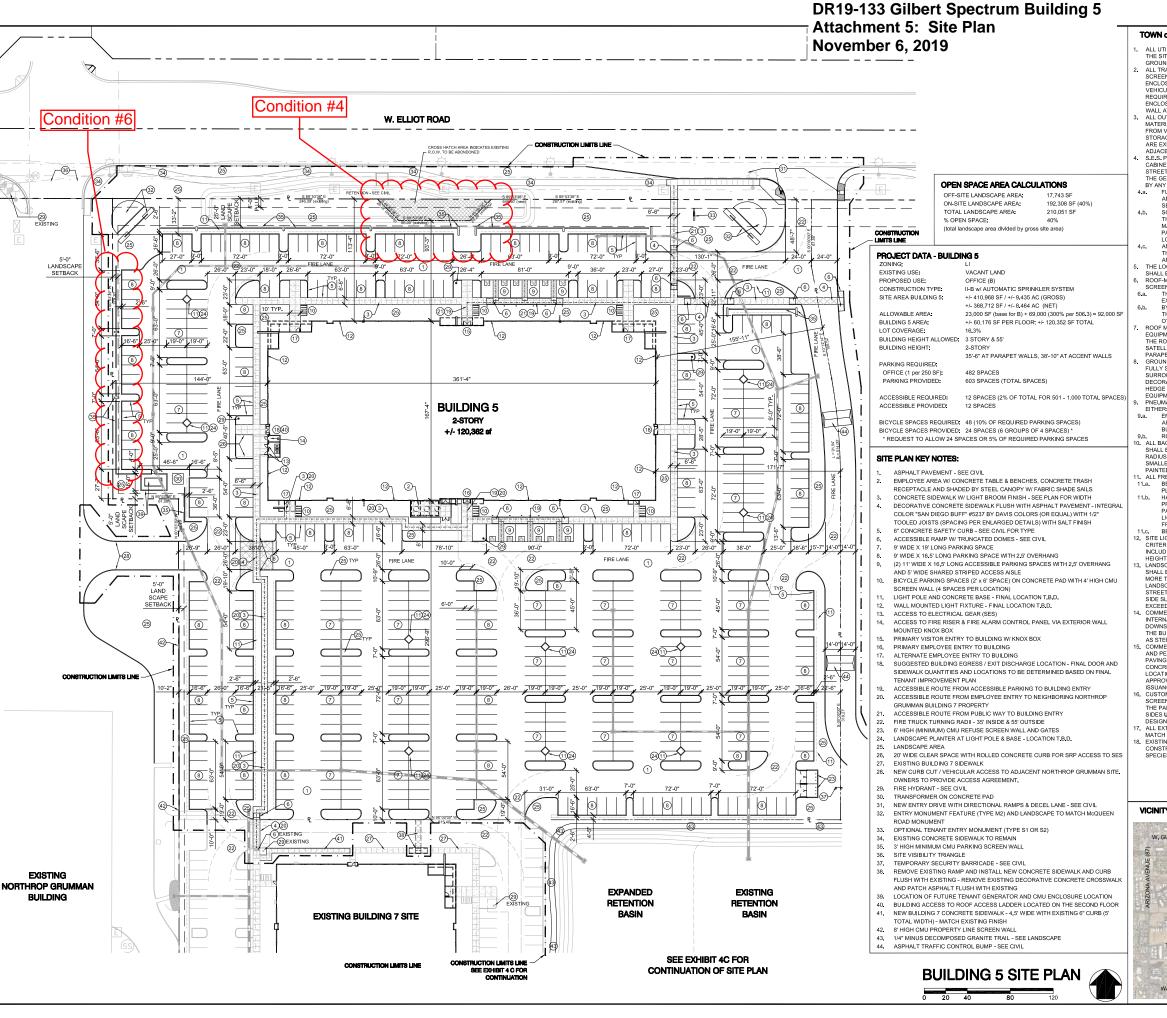

#### TOWN of GILBERT STANDARD SITE PLAN NOTES:

- ALL UTILITY LINES LESS THAN 69 KV ON OR CONTIGUOUS T THE SITE SHALL BE INSTALLED OR RELOCATED UNDER
- ALL TRASH ENCLOSURES SHALL INCLUDE FULLY OPAQUE SCREENING GATES, FINISHED AND PAINTED TO MATCH THE ENCLOSURE. SCREENING GATES, SHALL NOT OPEN INTO VEHICULAR DRIVE ASILES. TRASH ENCLOSURES ARE NOT REQUIRED IN INDUSTRIAL DISTRICTS IF LOCATED INSIDE AN ENCLOSED YARD WHICH IS SCREENED BY A PERIMETER WALL AT LEAST 6 FEET IN HEIGHT.
  ALL OUTDOOR STORAGE AREAS FOR STORAGE OF MATERIALS AND EQUIPMENT SHALL BE FULLY SCREENED FROM VIEW BY A 5' SOLID MASONRY WALL, INDUSTRIAL STORAGE SCREEN WALLS SHALL BE FINISHED WHERE THEY ARE EXPOSED TO PUBLIC YEW FROM STREETS OR ADJACENT NON-INDUSTRIAL USES. ALL TRASH ENCLOSURES SHALL INCLUDE FULLY OPAQUE
- S.E.S. PANELS AND ANY OTHER ABOVE GROUND UTILITY CABINETS SHALL BE FULLY SCREENED FROM VIEW FROM STREETS OR FROM AREAS ACCESSIBLE TO CUSTOMERS AND
- STREETS OR FROM AREAS ACCESSIBLE TO CUSTOMERS AND THE GENERAL PUBLIC. SCREENING MAY DE ACCOMPLISHED BY ANY ONE OF THE FOLLOWING METHODS:

  a. FULLY RECESSING THE CABINET INTO THE BUILDING AND ENCLOSING IT BY A SOLID DOOR OR DOORS SEPARATE FROM THE CABINET;

  b. SCREENING WITH A DECORATIVE MASONRY WALL OF THE SAME HEIGHT AS THE PARIL. THE SCREEN WALL PARALLEL TO THE CABINET; DEPENDING ON THE LOCATION OF THE CABINET; DEPENDING ON THE LOCATION OF THE CABINET;

  c. AN ALTERNATE SCREENING METHOD APPROVED BY THE PLANNING DEPARTMENT PRING TO ISSUANCE OF
- THE PLANNING DEPARTMENT PRIOR TO ISSUANCE OF
- THE LOCATION OF ALL ELECTRICAL UTILITY EQUIPMENT
- THE LOCATION OF ALL ELECTRICAL UTILITY EQUIPMENT SHALL BE IDENTIFIED ON THE CONSTRUCTION PLANS. ROOF-MOUNTED MECHANICAL EQUIPMENT SHALL BE FULLY SCREENED BY EITHER ONE OF THE FOLLOWING METHODS: 6a. THE PARAPET WALL OF THE BUILDING SHALL EQUAL OR EXCEED THE HEIGHT OF THE MECHANICAL LUNIS, OF 6b. BY LOCATING THE MECHANICAL EQUIPMENT BEHIND THE ROOF PLANES IN THE CASE OF MANSARD,HIP OR OTHER FLAT ROOF.

  ROOF MOUNTED MECHANICAL EQUIPMENT ENCLOSURES OR EQUIPMENT SCREENING WALLS SHALL NOT PROJECT ABOVE THE ROOF PARAPET. TO THE EXTENT PERMITTED BY LAW, SATELLITE DISHES SHALL BE FULLY SCREENED BY A.W. SATELLITE DISHES SHALL BE FULLY SCREENED BY A. PARAPET WALL.
- PARAPET WALL. GROUND MOUNTED MECHANICAL EQUIPMENT SHALL BE FULLY SCREENED FROM VIEW (FROM STREETS OR SURROUNDING COMMERCIAL USES) BY A COMBINATION OF DECORATIVE WALLS AND AN EVERGREEN VEGETATIVE HEDGE EQUAL TO OR EXCEEDING THE HEIGHT OF THE
- :QUIPMENT. PNEUMATIC TUBES, WHETHER METAL OR PLASTIC, SHALL B
- HER:
  ENCLOSED IN PILASTERS, COLUMNS OR OTHER
  ARCHITECTURAL FEATURES OF THE CANOPY OR
  BUILDING, OR:
- ROUTED UNDER GROUND. 9.b. ROUTED UNDER GROUND.

  3. ALL BACKFLOW PREVENTION DEVICES LARGER THAN 2"
  SHALL BE SCREENED WITH LANDSCAPE LOCATED WITHIN A 6"
  RADIUS OT THE DEVICE, ALL BACKFLOW PREVENTERS 2" OR
  RADIUS OT THE DEVICE, ALL BACKFLOW PREVENTERS 2" OR
  RAMALER SHALL BE PLACED IN A LOCKED WIRE MESH CAGE
  PAINTED TO MATCH THE PRIMARY BUILDING COLOR.

  1. ALL FREESTANDING LIGHT POLES SHALL:
  11.a. BE LOCATED WITHIN LANDSCAPED AREAS OR
  PLANTERS ISLANDS.
  11.b. HAVE A CONCRETE BASES PAINTED TO MATCH THE
  PRIMARY BUILDING COLOR OR FINISHED TO MATCH
  PARKING SCREEN WALLS. CONCRETE BASES FOR
  LIGHT POLES SHALL NOT EXCEED A HEIGHT OF 30"
  FROM ADJACENT GRADE.

  11.G. BE LOCATED TO AVOID CONFLICT WITH TREES.

- FROM ADJACENT GRADE.

  1.6. BE LOCATED TO AVOID CONFLICT WITH TREES.
  SITE LIGHTING SHALL COMPLY WITH THE LIGHT AND GLARE
  CRITERIA SET FORTH IN SECTION 4.103 OF THE LCD.
  INCLUDING A MAXIMUM FREESTANDING LIGHT FIXTURE
- INCLUDING A MAXIMUM FREESTANDING LIGHT FIXTURE HEIGHT OF 25.

  LANDSCAPED AREAS ADJACENT TO PUBLIC RIGHT-OF-WAY SHALL BE MOUNDED AND NATURALLY CONTOURED. NO MORE THAN 50% OF THE REQUIRED (RIGHT-OF-WAY AND LANDSCAPING TRONTING ADJACENT STREETS MAY BE USED FOR RETENTION. RETENTION AREA SIDE SLOPES SHALL BE VARIED, AND NO SLOPE SHALL EXCEED A 4:1 MAXIMUM.

  COMMERCIAL BUILDING DOWNSPOUTS SHALL BE INTERNALIZED. INDUSTRIAL BUILDINGS MAY USE EXPOSED DOWNSPOUTS IF ARTICULATED WITH THE ARCHITECTURE OF THE BUILDING AND BUILT WITH A DURABLE MATERIAL SUCH AS STEEL.
- COMMERCIAL DEVELOPMENT VEHICULAR ACCESS POINTS COMMERCIAL DEVELOPMENT VEHICULAR ACCESS POINTS AND PEDESTRIAN ACCESS WAYS SHALL INCLIUDE SPECIAL PAVING TREATMENT SUCH AS INTEGRAL COLOR STAMPED CONCRETE, BOAMANITE, OR SIMILAR ALTERNATIVE. LOCATION AND MATERIAL SHALL BE REVIEWED AND APPROVED BY THE PLANNING DEPARTMENT PRIOR TO THE ISSUANCE OF A BUILDING PERMIT. CUSTOMER, EMPLOYEE AND VISITOR PARKING SHALL BE SCREENED FROM STREET VIEW BY LOW MASONRY WALLS. THE PARKING SCREEN WALLS SHALL BE FINISHED ON BOTS DIES USING THE SAME MATERIALS AND COLORS, AND DA DESIGN TO COMPLEMENT THAT OF THE MAIN BUILDING. ALL EXTERIOR METAL BE FINISHED OR PAINTED TO
- ALL EXTERIOR METAL SHALL BE FINISHED OR PAINTED TO
- MATCH THE APPROVED PROJECT COLORS.
  EXISTING ON-SITE PLANT MATERIAL DAMAGED DURING
- CONSTRUCTION SHALL BE REPLACED WITH COMPARABLE SPECIES AND SIZE.









**GILBERT SPECTRUM** 

#### **DESIGN REVIEW**

**BUILDING 5** 

Issue Date:	10,17,2019
Scale:	1" = 40'
Drawn By:	EF
REVISIONS:	


#### VICINITY MAP:



BUILDING 5 SITE PLAN

**EXHIBIT 4B** 

A-101

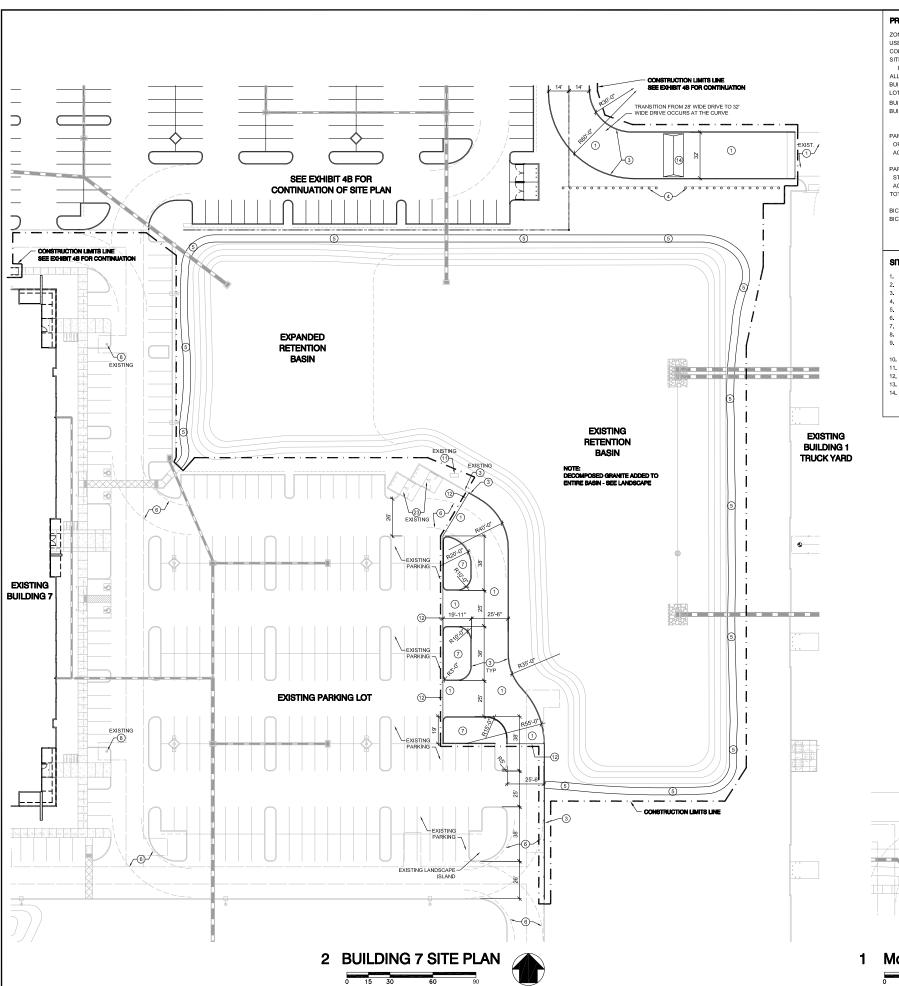

#### PROJECT DATA - BUILDING 7 (EXISTING)

OFFICE (B)

CONSTRUCTION TYPE: ILB

SITE AREA (NET)

BUILDING 7: +/- 222.637 SF / +/- 5.111 AC

ALLOWABLE AREA: BUILDING 1 AREA: 23,000 SF (base for B) + 69,000 (300% per 506.3) = 92,000 SF +/- 60,181 SF

LOT COVERAGE: 27.0%

BUILDING HEIGHT ALLOWED: 3 STORY & 55'

BUILDING HEIGHT: 1-STORY; 23'-6" AT PARAPET WALLS, 27'-0" AT ACCENT WALLS

PARKING REQUIRED:

OFFICE (1 per 250 SF):

8 SPACES (BASED ON 301 - 400 TOTAL SPACES) ACCESSIBLE REQUIRED:

PARKING PROVIDED:


STANDARD (EXISTING): 293 SPACES ACCESSIBLE (EXISTING): 8 SPACES 301 SPACES

BICYCLE SPACES REQUIRED: 24 (10% OF REQUIRED PARKING SPACES)

BICYCLE SPACES PROVIDED: 24 SPACES (6 GROUPS OF 4 SPACES)

#### SITE PLAN KEY NOTES:

- ASPHALT PAVEMENT SEE CIVIL
- CONCRETE SIDEWALK W/ LIGHT BROOM FINISH SEE PLAN FOR WIDTH
- 6" CONCRETE SAFETY CURB SEE CIVIL FOR TYPE
- TEMPORARY SECURITY BARRICADE SEE CIVIL
  1/4" DECOMPOSED GRANITE TRAIL SEE LANDSCAPE
- FIRE TRUCK TURNING RADII 35' INSIDE & 55' OUTSIDE
- LANDSCAPE AREA FIRE HYDRANT SEE CIVIL
- EXISTING CONCRETE CURB. GUTTER & SIDEWALK TO BE REMOVED AS NEEDED
- TO INSTALL NEW DECEL LANE SEE CIVIL
  NEW DIRECTIONAL ACCESSIBLE RAMPS SEE CIVIL
- EXISTING ELECTRICAL LITH ITY CABINET
- EXISTING TO NEW PAVEMENT TRANSITION SEE CIVIL EXISTING CONCRETE RAMPS AND SIDEWALK TO BE REMOVED - SEE CIVIL
- ASPHALT TRAFFIC CONTROL BUMP SEE CIVIL

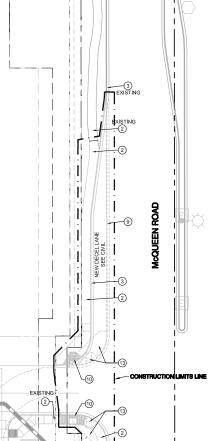

1 McQUEEN ROAD DECEL LANE



#### TOWN of GILBERT STANDARD SITE PLAN NOTES:

- ALL UTILITY LINES LESS THAN 69 KV ON OR CONTIGUOUS TO THE SITE SHALL BE INSTALLED OR RELOCATED UNDER
- THE SITE SHALL BE INSTALLED OR RELOCATED UNDER GROUND.

  ALL TRASH ENCLOSURES SHALL INCLUDE FULLY OPAQUE SCREENING GATES, FINISHED AND PAINTED TO MATCH THE ENCLOSURE. SCREENING GATES SHALL NOT OPEN INTO YEHICULAR DRIVE AISLES, TRASH ENCLOSURES ARE NOT REQUIRED IN INDUSTRIAL DISTRICTS IF LOCATED INSIDE AN ENCLOSED YARD WHICH IS SCREENED BY A PERIMETER WALL AT LEAST 6 FEET IN HEIGHT.

  ALL OUTDOOR STORAGE AREAS FOR STORAGE OF MATERIALS AND EQUIPMENT SHALL BE FULLY SCREENED FROM YIEW BY A 8' SOLD MASONRY WALL, INDUSTRIAL STORAGE SCREEN WALLS SHALL BE FINISHED WHERE THEY ARE EXPOSED TO PUBLIC YEW FROM STREETS OR ADJACENT NON-INDUSTRIAL USES.

  SLES, PARKES AND ANY OTHER ABOVE GROUND UTILITY
- ARE EXPOSED TO PUBLIC VIEW FROM STREETS OR ADJACENT NON-INDUSTRIAL USES.

  S.E.S. PANELS AND ANY OTHER ABOVE GROUND UTILITY CABINETS SHALL BE FULLY SCREENED FROM WIEW FROM STREETS OR FROM AREAS ACCESSIBLE TO CUSTOMERS AND THE GENERAL PUBLIC. SCREENING MAY BE ACCOMPLISHED BY ANY ONE OF THE FOLLOWING METHODS:

  4.a. FULLY RECESSING THE CABINET INTO THE BUILDING AND ENCLOSING IT BY A SOLID DOOR OR DOORS SEPARATE FROM THE CABINET:

  4.b. SCREENING WITH A DECORATIVE MASONRY WALL OF THE SAME HEIGHT AS THE PANEL. THE SCREEN WALL MAY BE L-SHAPED. U-SHAPED OR A STRAIGHT WALL PARALLEL TO THE CABINET; DEPENDING ON THE LOCATION OF THE CABINET;

  4.c. AN ALTERNATE SCREENING METHOD APPROVED BY THE PLANNING DEPARATMENT PRIOR TO ISSUANCE OF

- THE PLANNING DEPARTMENT PRIOR TO ISSUANCE OF
- THE LOCATION OF ALL ELECTRICAL UTILITY EQUIPMENT
- THE LOCATION OF ALL ELECTRICAL UTILITY EQUIPMENT SHALL BE IDENTIFIED ON THE CONSTRUCTION PLANS. ROOF-MOUNTED MECHANICAL EQUIPMENT SHALL BE FULLY SCREENED BY EITHER ONE OF THE FOLLOWING METHODS.

  5.a. THE PARAPET WALL OF THE BUILDING SHALL EQUAL OR EXCEED THE HEIGHT OF THE MECHANICAL LUNIS, OR.

  5.b. BY LOCATING THE MECHANICAL EQUIPMENT BEHIND THE ROOF PLANES IN THE CASE OF MANSARD, HIP OR OTHER FLAT ROOF.

  ROOF MOUNTED MECHANICAL EQUIPMENT ENCLOSURES OR EQUIPMENT SCREENING WALLS SHALL NOT PROJECT ABOVE THE ROOF PARAPET, TO THE EXTENT PERMITTED BY LAW, SATELLITE DISHES SHALL BE FULLY SCREENED BY A MARAPET WALL.
- PARAPET WALL. GROUND MOUNTED MECHANICAL EQUIPMENT SHALL BE FULLY SCREENED FROM VIEW (FROM STREETS OR SURROUNDING COMMERCIAL USES) BY A COMBINATION OF DECORATIVE WALLS AND AN EVERGREEN VEGETATIVE HEDGE EQUAL TO OR EXCEEDING THE HEIGHT OF THE
- REUGE EQUAL TO UR EXCEEDING THE HEIGHT OF THE COUJPMENT. PNEUMATIC TUBES, WHETHER METAL OR PLASTIC, SHALL BE EITHER: a. ENCLOSED IN PILASTERS, COLUMNS OR OTHER ARCHITECTURAL FEATURES OF THE CANOPY OR BUILDING, OR:
- ROUTED UNDER GROUND.
- 9.b. ROUTED UNDER GROUND.

  1. ALL BACKELOW PREVENTION DEVICES LARGER THAN 2"
  SHALL BE SCREENED WITH LANDSCAPE LOCATED WITHIN ACT
  SHALL BE SCREENED WITH LANDSCAPE LOCATED WITHIN ACT
  SHALL BE PLACED IN A LOCKED WIRE MESH CAGE
  MAINTED TO MATCH THE PRIMARY BUILDING COLOR.

  1. ALL FREESTANDING LIGHT POLES SHALL:
  11.a. BE LOCATED WITHIN LANDSCAPED AREAS OR
  PLANTERS ISLANDS.
  11.b. HAVE A CONCRETE BASES PAINTED TO MATCH THE
  PRIMARY BUILDING COLOR OR FINISHED TO MATCH
  PARKING SCREEN WALLS. CONCRETE BASES FOR
  LIGHT POLES SHALL NOT EXCEED A HEIGHT OF 30"
  FROM ADJACENT GRADE.

  11.G. BE LOCATED TO AVOID CONFLICT WITH TREES.

- FROM ADJACENT GRADE.


  11.c. BE LOCATED TO AVOID CONFLICT WITH TREES.

  12. SITE LIGHTING SHALL COMPLY WITH THE LIGHT AND GLARE
  CRITERIA SET FORTH IN SECTION 4.103 OF THE LCD.
  INCLUDING A MAXIMUM FREESTANDING LIGHT FIXTURE
- INCLUDING A MAXIMUM FREESTANDING LIGHT FIXTURE HEIGHT OF 25'.

  3. LANDSCAPED AREAS ADJACENT TO PUBLIC RIGHT-OF-WAY SHALL BE MOUNDED AND NATURALLY CONTOURED. NO MORE THAN 50% OF THE REQUIRED (RIGHT-OF-WAY AND LANDSCAPING FRONTING ADJACENT STREETS MAY BE USED FOR RETENTION. RETENTION AREA SIDE SLOPES SHALL BE VARIED, AND NO SLOPE SHALL EXCEED A 4:1 MAXIMUM.

  4. COMMERCIAL BUILDING DOWNSPOUTS SHALL BE INTERNALIZED. INDUSTRIAL BUILDINGS MAY USE EXPOSED DOWNSPOUTS IF ARTICULATED WITH THE ARCHITECTURE OF THE BUILDING AND BUILT WITH A DURABLE MATERIAL SUCH AS STEEL.
- COMMERCIAL DEVELOPMENT VEHICULAR ACCESS POINTS 5. COMMERCIAL DEVELOPMENT VEHICULAR ACCESS POINTS AND PEDESTRIAN ACCESS WAYS SHALL INCLIDE SPECIAL PAVING TREATMENT SUCH AS INTEGRAL COLOR STAMPED CONCRETE BOAMANITE, OR SIMILAR A LTERNATIVE. LOCATION AND MATERIAL SHALL BE REVIEWED AND APPROVED BY THE PLANNING DEPARTMENT PRIOR TO THE ISSUANCE OF A BUILDING PERMIT.
  CUSTOMER, EMPLOYEE AND VISITOR PARKING SHALL BE SCREENED FROM STREET IVEW BY LOW MASONRY WALLS. THE PARKING SCREEN WALLS SHALL BE FINISHED ON BOTH SIDES USING THE SAM ATTERIALS AND COLORS, AND A DESIGN TO COMPLEMENT THAT OF THE MAIN BUILDING.
  ALL EXTERIOR METALS HALL BE FINISHED OR PAINTED TO

- DESIGN TO COMPLEMENT THAT OF THE MAIN BUILDING,
  ALL EXTERIOR METAL SHALL BE FINISHED OR PAINTED TO
  MATCH THE APPROVED PROJECT COLORS.
  EXISTING ON-SITE PLANT MATERIAL DAMAGED DURING
  CONSTRUCTION SHALL BE REPLACED WITH COMPARABLE
  SPECIES AND SIZE.

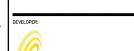

SunCap

PROPERTY GROUP







### **GILBERT SPECTRUM**

#### **BUILDING 5 DESIGN REVIEW**

PROJECT TITLE:

Issue Date:	10,17,2019
Scale:	1" = 40'
Drawn By:	EF

#### VICINITY MAP:




REVISIONS:


BUILDING 5 SITE PLAN

**EXHIBIT 4C** 


A-101a

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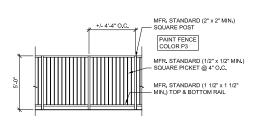


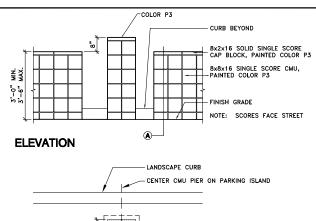
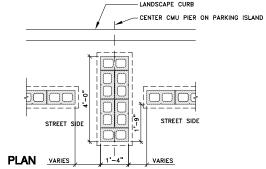
# 5 PARKING SCREEN WALL DETAIL 3 PATI

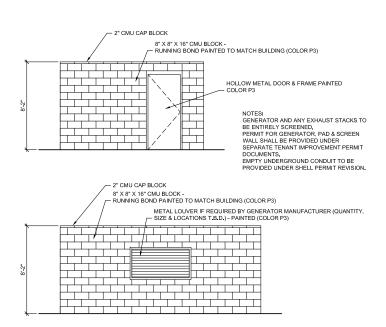

#### **6 GENERATOR SCREEN WALL**



7 PATIO W.I. FENCE


# Park Series Waste and Ash Receptacles STOCK P DIAMETER HEIGHT UNER CAP, PSWR2426 24" 20" 20 OAL PSWR2426 28" 32" 30 OAL PSRA1522 13" 22" With Sifter PBAN1624 16" 24" With 9ffer All waste medipack until some complete with waste liner and spun aluminum 16. All ash receptace come complete with clean-out sifter White or back sand to fill the receptacle can be supposed upon request.


COLOR TO BE MANUFACTURER'S STANDARD INTEGRAL COLOR "SAGE", SAND BLAST FINISH

#### **3 PATIO TRASH RECEPTACLE**




MADRAX DIVING
GRABER MAIN FACTURING
GRABER MAIN FACTURING
GROUNERK
P(800) 448-7931, P(608) 849-1080, F(608) 849
WWW MADRAX COM, E-MAIL: SALES@MADRAX
WWW MADRAX COM, E-MAIL: SALES@MADRAX

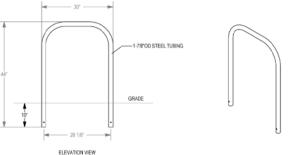

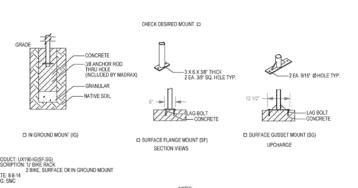


#### 4 BIKE RACK CUT SHEET

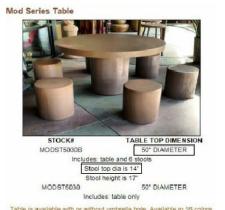


COLOR TO BE MANUFACTURER'S STANDARD INTEGRAL COLOR "SAGE", SMOOTH FINISH

#### 1 PATIO TABLE & SEATING

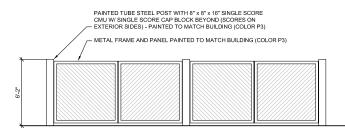

#### **ELEVATION**

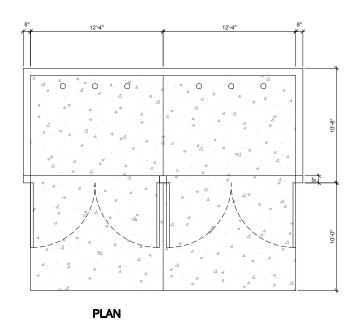

2 REFUSE SCREEN WALL



DESIGNER





GRAYCOR

# Date: Description:

GILBERT SPECTRUM

PROJECT TITLE:

BUILDING 5

DESIGN REVIEW

Issue Date:	10.17.2019
Scale:	1/4" = 1'-0"
Drawn By:	EF
REVISIONS:	

DRAWING TITLE:

ARCHITECTURAL DETAILS - SITE

EXHIBIT 4D

DRAWING NUMBER:

A-501

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eflake | S:\38017 - Gilbert Spectrum B-5\38017 A-501 DRB DETAIL


COPYRIGI

**ELEVATION** 



LAN

4 OPTIONAL TENANT SIGN WALL (S2)

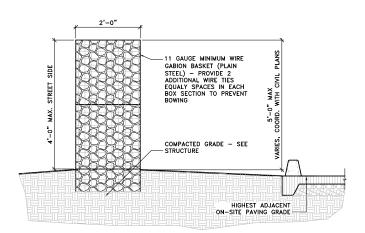

1 GABION WALL DETAIL



**BALMER** 

SunCap
PROPERTY GROUP

GRAYCOR

# Date: Description:
REVISIONS:
PROJECT TITLE:

GILBERT SPECTRUM

BUILDING 5
DESIGN REVIEW

Issue Date:	10,17,2019
Scale:	1/4" = 1'-0"
Drawn By:	EF
REVISIONS:	

DRAWING TITLE:

ARCHITECTURAL DETAILS - SITE

**EXHIBIT 4E** 

KAWING NOMBER.

A-502

GABION WALL W/
4-5-0"

GABION WALL W/
4-5-0"

ALUMINUM REVERSE PAN CHANNEL LETTER - BACKLIT
(UNDER SEPARATE PERMIT)

CORTEN (PLAIN) STEEL
BEAM - SEE
STRUCTURAL


CORTEN (PLAIN) STEEL
COLUMNS IN GABION WALL
TYP. - SEE STRUCTURAL

5-6


12-0"

44-0"


2 MONUMENT SIGN WALL (M2) ELEVATION

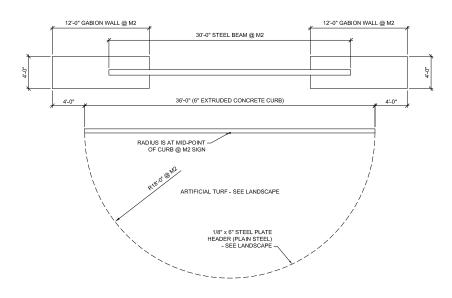

3 MONUMENT SIGN WALL (M2) PLAN

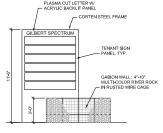


ELEVATION

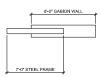

PLAN

5 OPTIONAL TENANT SIGN WALL (S1)

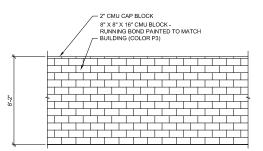


**6 PROPERTY LINE SCREEN WALL** 

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and the second of the second o

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SunCap PROPERTY GROU

DESIGNER:

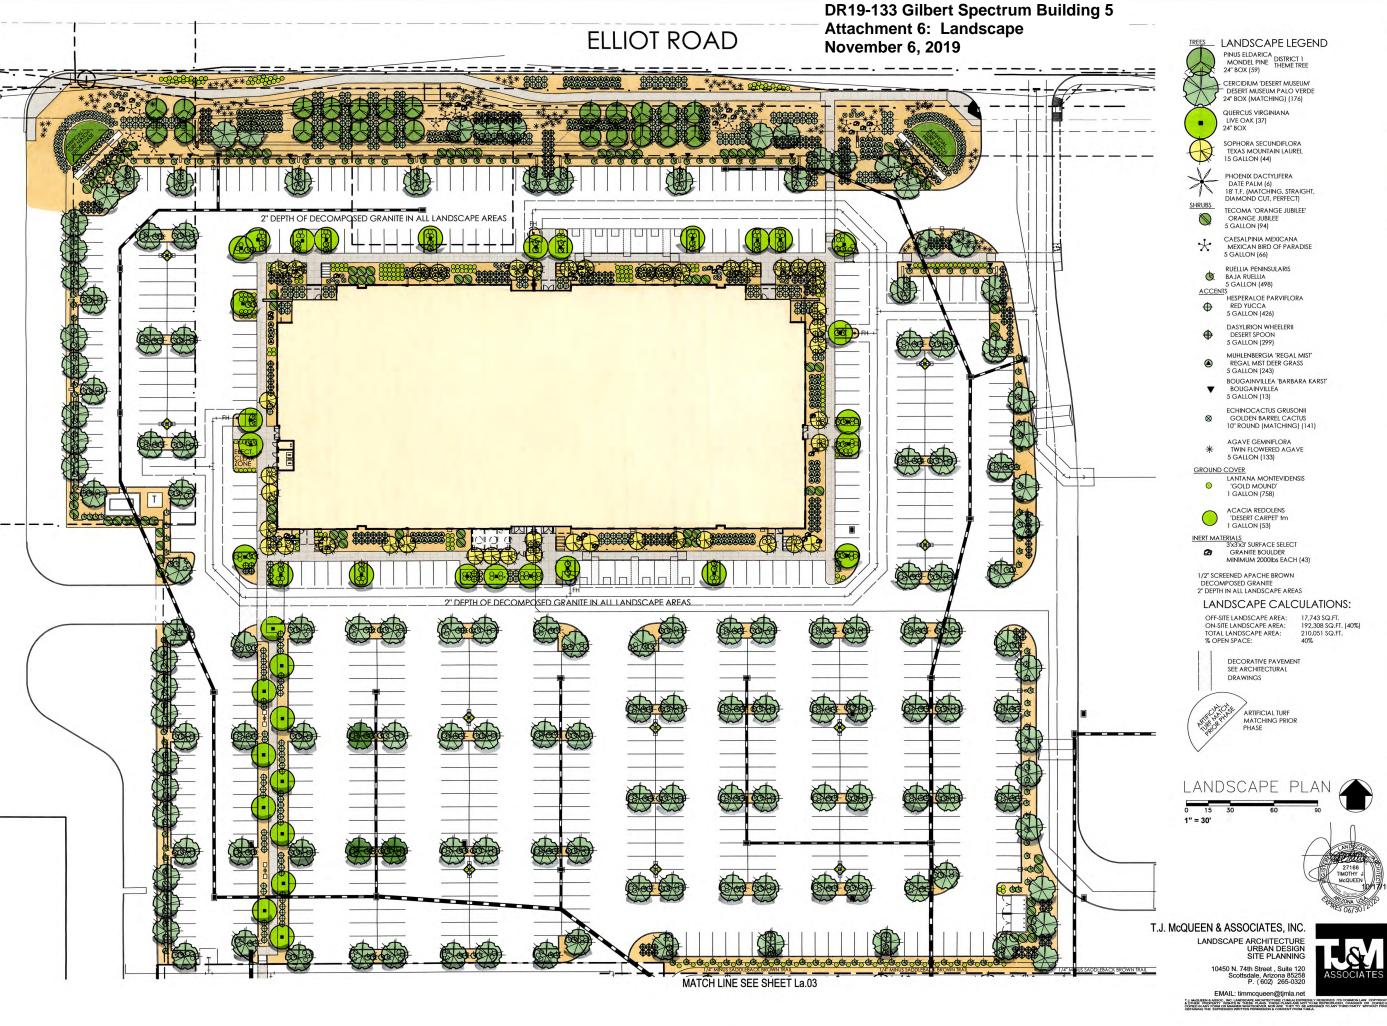

GRAYCOR Construction Company Inc.

# Date: Descrip

PROJECT TITLE:

**GILBERT SPECTRUM** 

Issue Date: 10/17/19
Scale: 1" = 30'
Drawn By: AWM


DRAWING TITLE:

REVISIONS:

LANDSCAPE PLAN

DRAWING NU

La.02

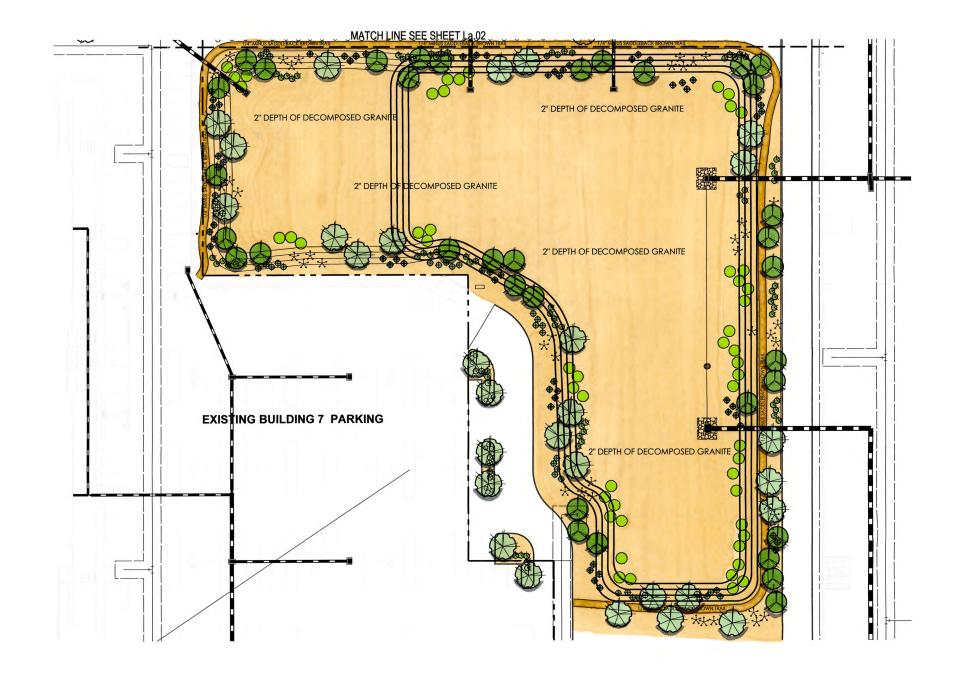





PINUS ELDARICA MONDEL PINE DISTRICT 1 MONDEL PINE THEME TREE 24" BOX (59) - CERCIDIUM 'DESERT MUSEUM'







SOPHORA SECUNDIFLORA TEXAS MOUNTAIN LAUREL 15 GALLON (44)



PHOENIX DACTYLIFERA DATE PALM (6) 18' T.F. (MATCHING, STRAIGHT, DIAMOND CUT, PERFECT)

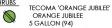

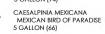



ACCENTS

HESPERALOE PARVIFLORA

RED YUCCA
5 GALLON (426)



MUHLENBERGIA 'REGAL MIST' REGAL MIST DEER GRASS 5 GALLON (243)

BOUGAINVILLEA 'BARBARA KARST' BOUGAINVILLEA 5 GALLON (13)

ECHINOCACTUS GRUSONII GOLDEN BARREL CACTUS 10" ROUND (MATCHING) (141)

AGAVE GEMNIFLORA TWIN FLOWERED AGAVE 5 GALLON (133)

GROUND COVER

LANTANA MONTEVIDENSIS

'GOLD MOUND'
1 GALLON (758)



## INERT MATERIALS 3'x3'x3' SURFACE SELECT

GRANITE BOULDER
MINIMUM 2000lbs EACH (43) 1/2" SCREENED APACHE BROWN


DECOMPOSED GRANITE 2" DEPTH IN ALL LANDSCAPE AREAS

#### LANDSCAPE CALCULATIONS:

OFF-SITE LANDSCAPE AREA: 17,743 SQ.FT. ON-SITE LANDSCAPE AREA:
TOTAL LANDSCAPE AREA:
% OPEN SPACE:

17,743 3Q.FT. 192,308 SQ.FT. (40%) 210,051 SQ.FT. 40%



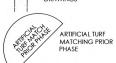







**GILBERT SPECTRUM** 

**SunCap** 

**BALMER** 

**GRAYCOR** 

PROPERTY GROUP



DRAWING TITLE:

PROJECT TITLE:

**LANDSCAPE PLAN** 

#### T.J. McQUEEN & ASSOCIATES, INC.


LANDSCAPE ARCHITECTURE URBAN DESIGN SITE PLANNING


EMAIL: timmcqueen@tjmla.net T.J. M-QUEEN A ASSOC, INC. LANGSCAPIE ARCHITECTURE (TAINA) EXPRESSLY RESERVES ITS COMMON LAW COPPRIGHT A OTHER I PROPERTY RESPIT SET THESE FLANS. THESE FLANS ARE NOT DIS RESPRODUCED, CHANGED OX. COMED IN COMED IN ANY FORM OR MANIFER WHATSOEVER, NOR ARE THEY TO BE ASSIGNED TO ANY THIRD PARTY WITHOUT FIRST CHYMAINST THE EXPRESSES WAITTEN FERMINISHIN A COMBINE FROM TAIN.



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#### - LANDSCAPE LEGEND

PINUS ELDARICA MONDEL PINE THEME TREE 24" BOX (59)

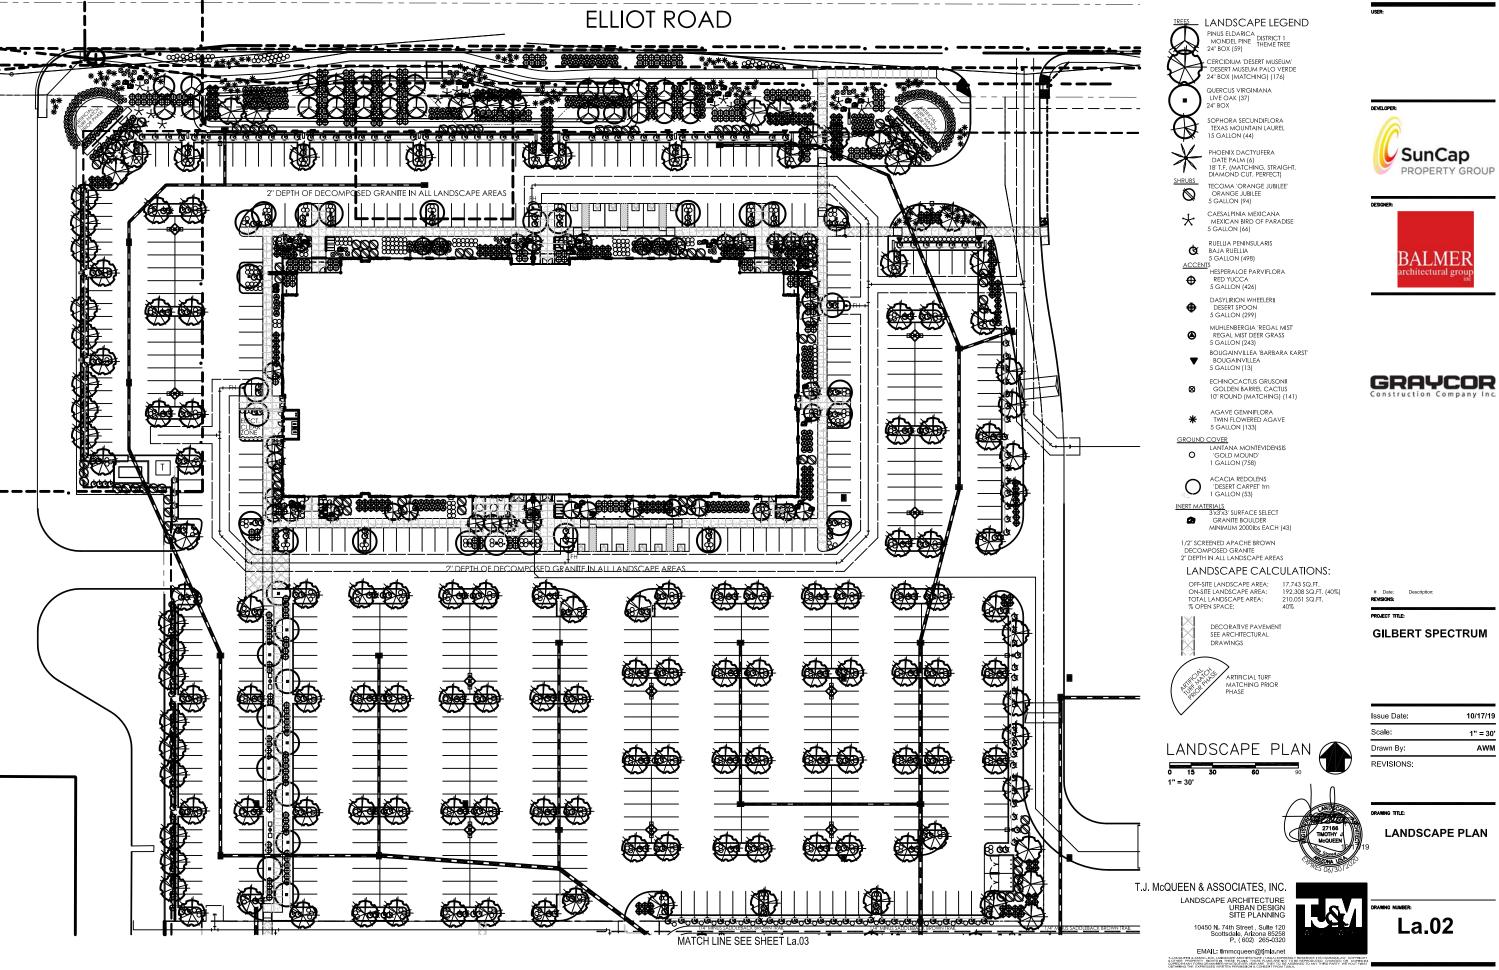DEVELOPER:

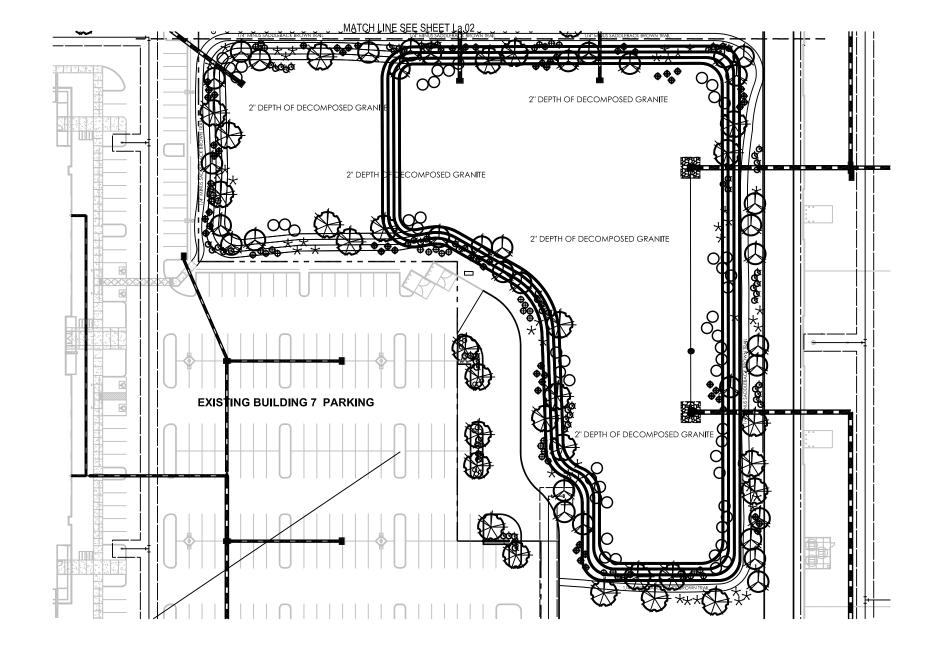SunCap

PROPERTY GROUP

**BALMER** 

**GRAYCOR** 





SOPHORA SECUNDIFLORA TEXAS MOUNTAIN LAUREL 15 GALLON (44)



PHOENIX DACTYLIFERA
DATE PALM (6)
18" T.F. (MATCHING, STRAIGHT,
DIAMOND CUT, PERFECT)

# Ø

TECOMA 'ORANGE JUBILEE' ORANGE JUBILEE 5 GALLON (94)



RUELLIA PENINSULARIS BAJA RUELLIA 5 GALLON (498)



ACCENTS

HESPERALOE PARVIFLORA

RED YUCCA
5 GALLON (426)

DASYLIRION WHEELERII DESERT SPOON 5 GALLON (299)

MUHLENBERGIA 'REGAL MIST' REGAL MIST DEER GRASS 5 GALLON (243)

BOUGAINVILLEA 'BARBARA KARST' BOUGAINVILLEA 5 GALLON (13)

ECHINOCACTUS GRUSONII GOLDEN BARREL CACTUS 10" ROUND (MATCHING) (141)

AGAVE GEMNIFLORA TWIN FLOWERED AGAVE 5 GALLON (133)

GROUND COVER

LANTANA MONTEVIDENSIS

O 'GOLD MOUND'
1 GALLON (758)

ACACIA REDOLENS
'DESERT CARPET' tm
1 GALLON (53)

# INERT MATERIALS 3'x3'x3' SURFACE SELECT GRANITE BOULDER MINIMUM 2000lbs EACH (43)

1/2" SCREENED APACHE BROWN DECOMPOSED GRANITE 2" DEPTH IN ALL LANDSCAPE AREAS

#### LANDSCAPE CALCULATIONS:


OFF-SITE LANDSCAPE AREA: 17,743 SQ.FT.
ON-SITE LANDSCAPE AREA: 192.308 SQ.FT. (40%)
TOTAL LANDSCAPE AREA: 210.051 SQ.FT.
% OPEN SPACE: 40%

DECORATIVE PAVEMENT SEE ARCHITECTURAL DRAWINGS







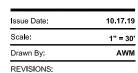

**GILBERT SPECTRUM** 



DRAWING TITLE:

PROJECT TITLE:

LANDSCAPE PLAN

T.J. McQUEEN & ASSOCIATES, INC. LANDSCAPE ARCHITECTURE

URBAN DESIGN SITE PLANNING


10450 N. 74th Street , Suite 120 Scottsdale, Artzona 85258 P. (602) 265-0320

EMAIL: timmcqueen@tjmla.net T.J. McQUEEN & ASSOC, INC. LANDSCAPE ARCHITECTURE IT MAIL PEOPRESSLY RESERVES ITS COMMON LAW COPYRIGE A OTHER PROPERTY RENTRISH THESE PLANS. THESE PLANS ARE NOT TO BE REPROQUED. CHANGED OF COPIED IN ANY FORM OR MANNER WHATSDEVER, NOR ARE THEY TO BE ASSIGNED TO ANY THRO PARTY WITHOUT FEODERANDED THE EXPRESSED WRITTEN PERMISSION & COMBONIT FROM THE EXPRESSED WRITTEN PERMISSION & COMBONIT FROM THE



La.03


COPYRIGHT © 2018

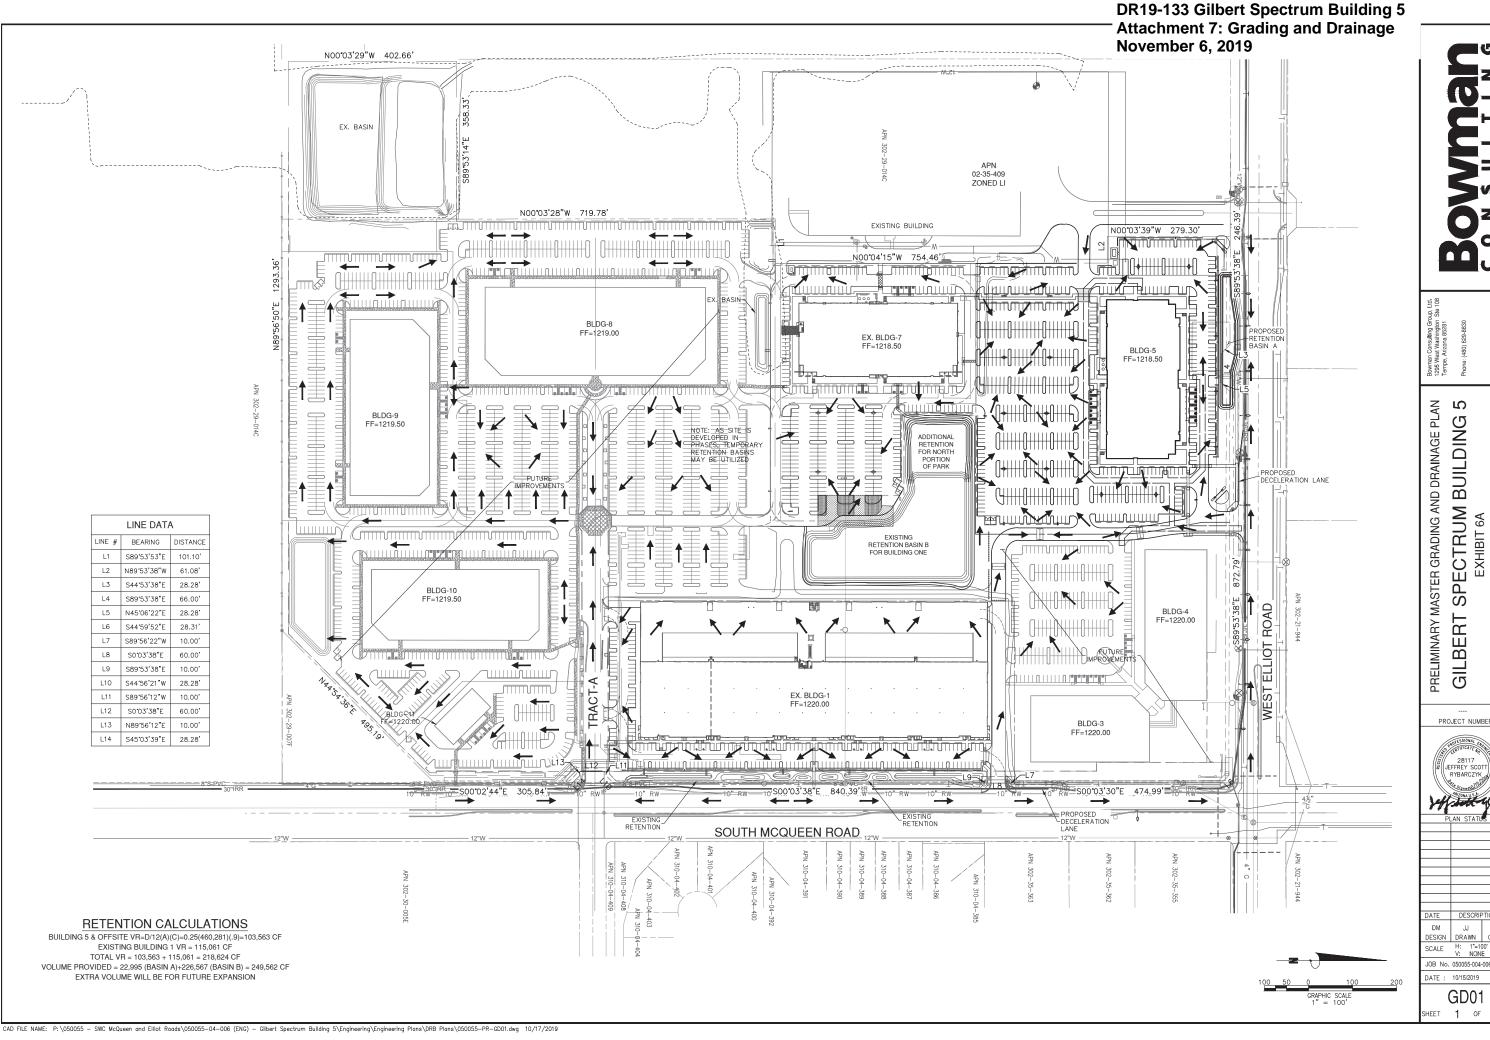



PROJECT NUMBER

DM JJ JSR DESIGN DRAWN CHKD SCALE H: 1"=100" V: NONE JOB No. 050055-004-006

GD01 HEET 1 OF 4

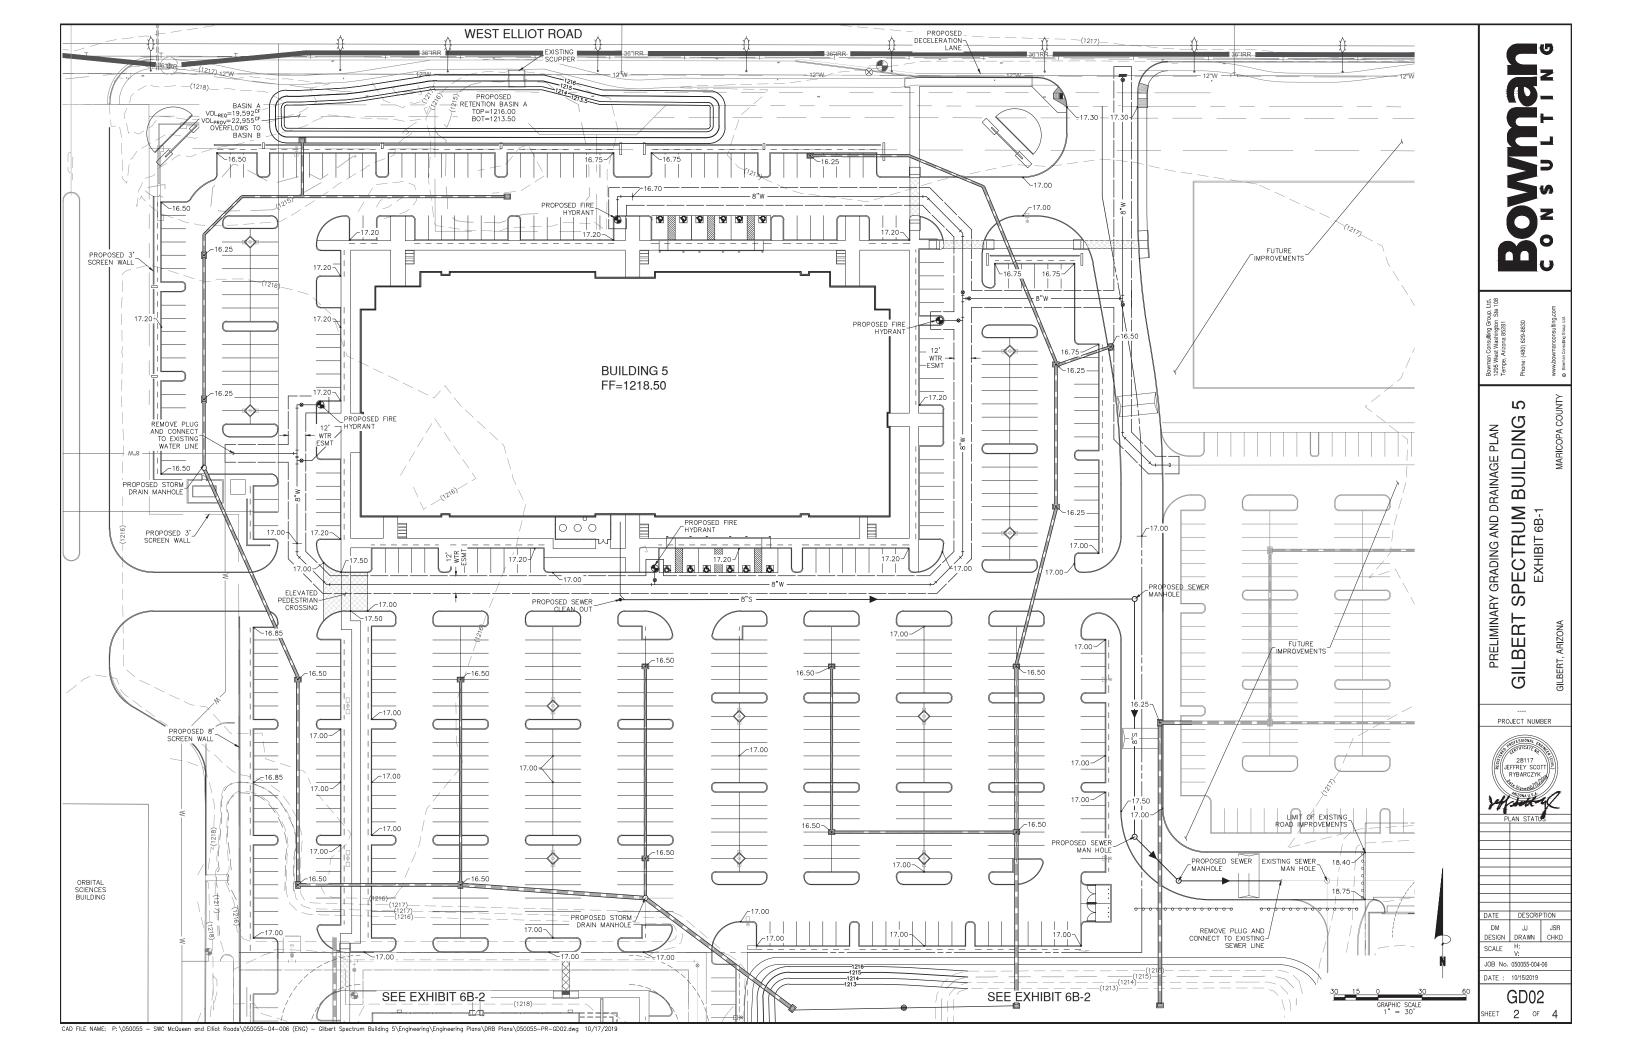

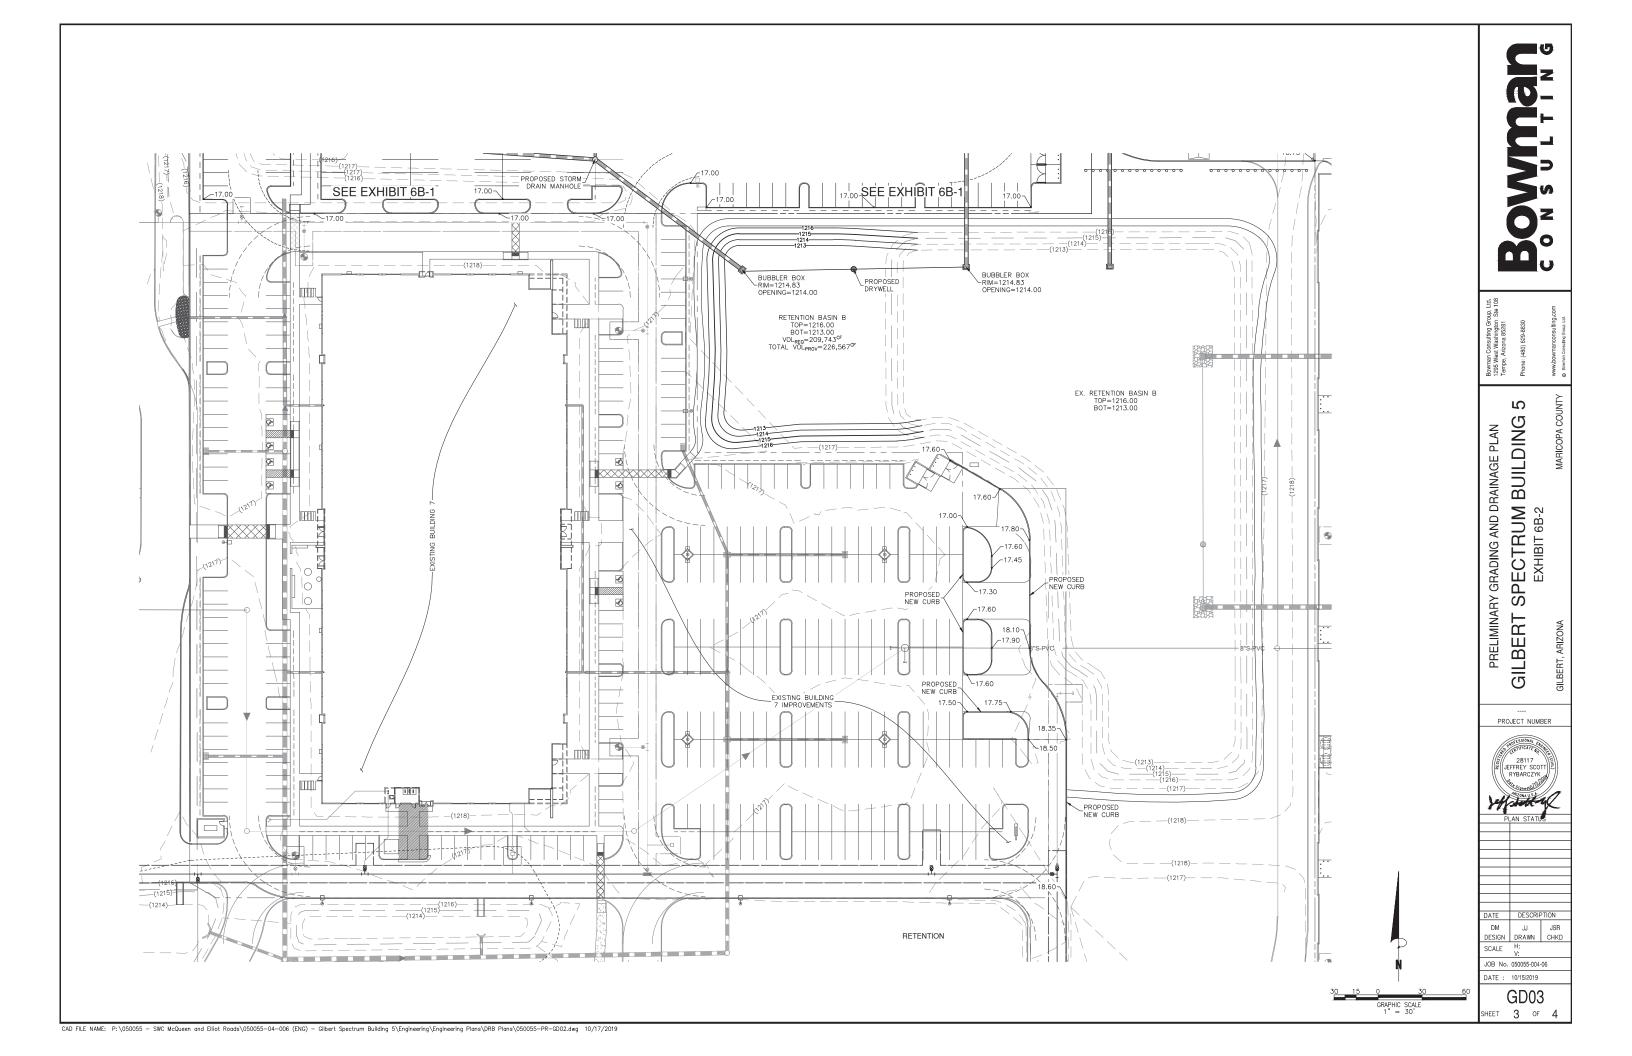

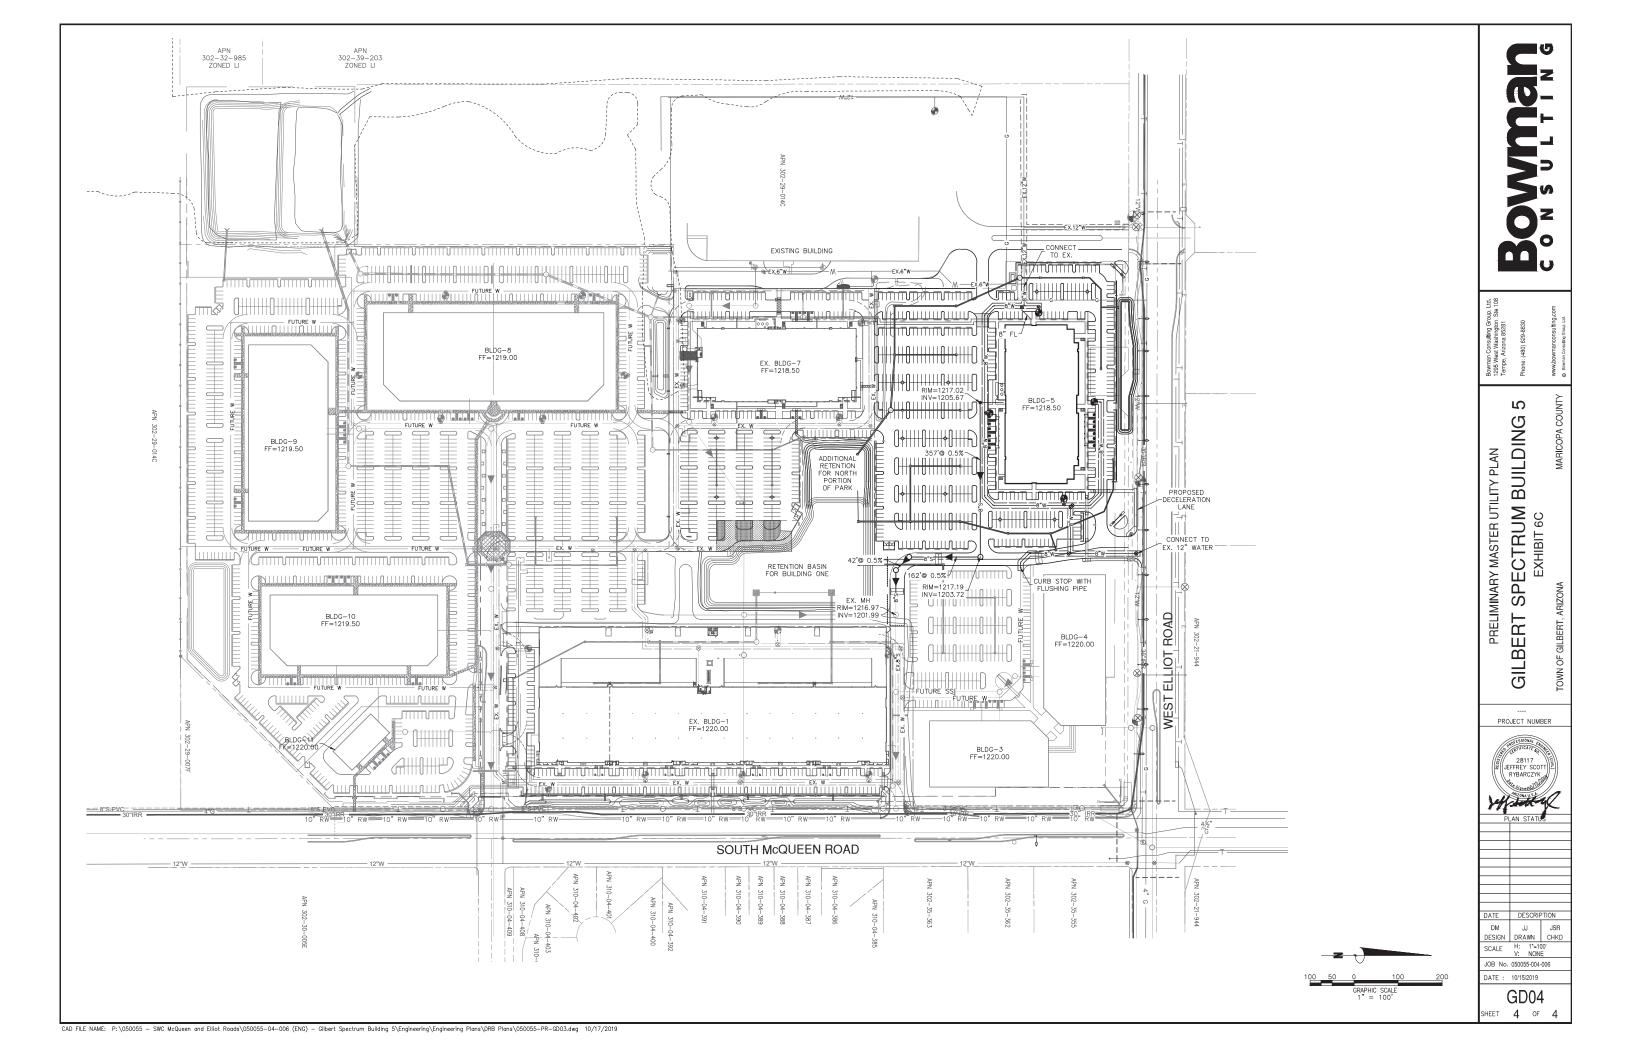

10.17.19



# **PAINT**



D1 DUNN EDWARDS WHOLE WHEAT' DE 6124



P3 DUNN EDWARDS ROXY BROWN' DE 6084

ALL COLORS TO BE DUNN EDWARDS PAINTS OR EQUAL




# 2 SCREEN WALL 8 x 8 x 16 SINCLE SCORE CMU WALL WITH PAINTED FINISH

# 3 GLASS PPG PACIFICA - 1 " INSULATED GLASS SOLARBAN 60 (3) U-VALUE OF 0.29 AND SHGC OF 0.25 CLEAR ANODIZED ALUMINUM FRAMES, TYPICAL


4 STONE VENEER
SEDONA RED FLAGSTONE 16"x24" TILE



P2 DUNN EDWARDS 'SAND DUNE' DE 6128

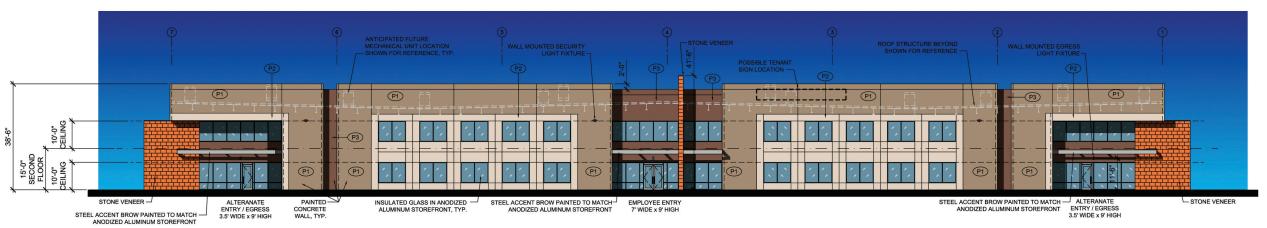


#### 1 NORTH ELEVATION

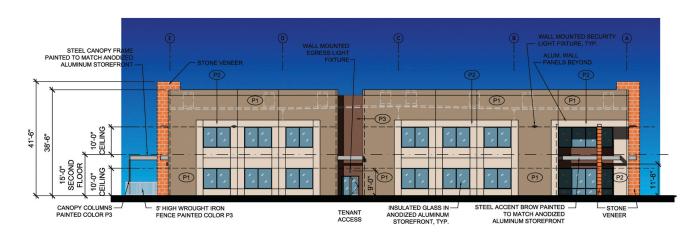



#### **3 EAST ELEVATION**

2 WEST ELEVATION

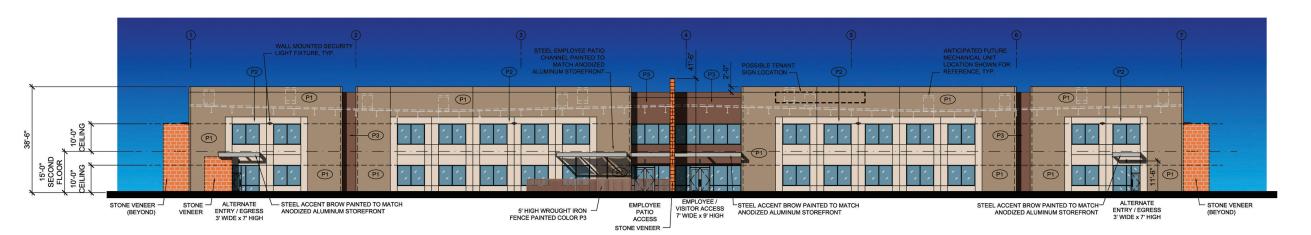

	PAINT COLOR SCHEDULE:	GLASS:		NOTES:
	P1 DUNN EDWARDS WHOLE WHEAT DE 6124	PPG PACIFICA - 1 " INSULATED GLASS SOLARBAN 60 (3)	1. 2.	CONCRETE TILT PANELS TO RECEIVE A SMOOTH UNIFORM FINISH, U.N.O.  PAINT COLORS SUBJECT TO CHANGE. NO COLOR SHALL HAVE A LIGHT REFLECTIVE VALUE
	P2 DUNN EDWARDS 'SAND DUNE' DE 6128	U-VALUE OF 0.29 AND SHGC OF 0.25 CLEAR ANODIZED ALUMINUM FRAMES, TYPICAL	3.	(LRV) GREATER THAN 79.  ALL SIGNAGE REQUIRES SEPARATE REVIEW AND PERMIT PROCESS, EXCEPT ADDRESS
	(P3) DUNN EDWARDS 'ROXY BROWN' DE 6084  ALL COLORS TO BE DUNN EDWARDS PAINTS OR EQUAL	STONE VENEER:		NUMBERS.  ALL ROOF MOUNTED MECHANICAL EQUIPMENT SHALL BE FULLY SCREENED BY PARAPET
		SEDONA RED FLAGSTONE 16X24* TILE	1	WALLS EQUAL TO, OR GREATER THAN, THE HIGHEST POINT ON THE MECHANICAL EQUIPMEN
			5.	SOLID MASONRY WALLS AND GATES EQUAL TO, OR GREATER THAN, THE HIGHEST POINT ON THE MECHANICAL EQUIPMENT SHALL SCREEN ALL GROUND MOUNTED MECHANICAL EQUIPMENT.



DEVELOPER:

SunCap
PROPERTY GROUP

DESIGNER:







# Date: Description:

PROJECT TIT

GILBERT SPECTRUM

BUILDING 5

DESIGN REVIEW

Issue Date:	10.17.2019
Scale:	1/16" = 1'-0"
Drawn By:	EF
REVISIONS:	

DRAWING TITLE:

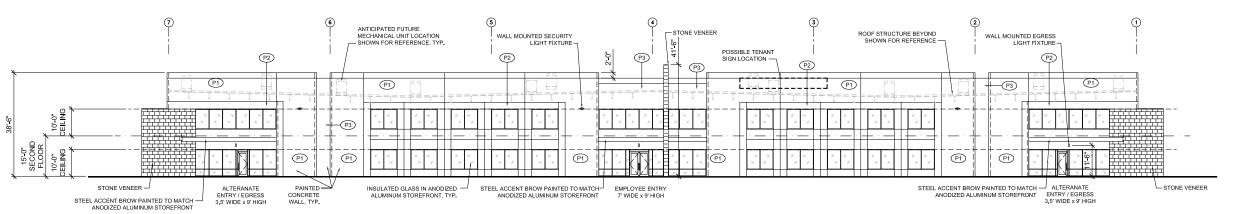
EXTERIOR ELEVATIONS

**EXHIBIT 8** 


DRAWING NUMBER:

A-201

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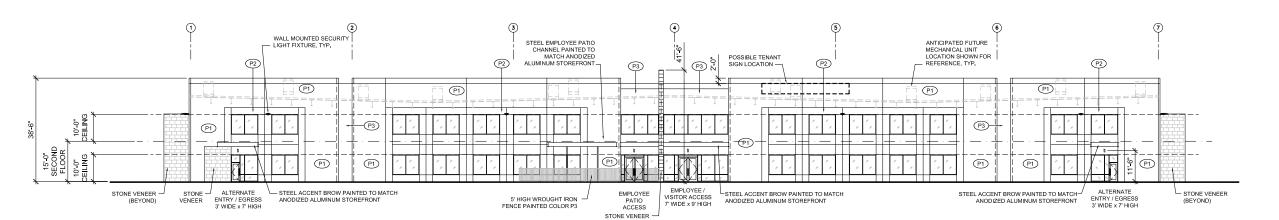


#### 1 NORTH ELEVATION

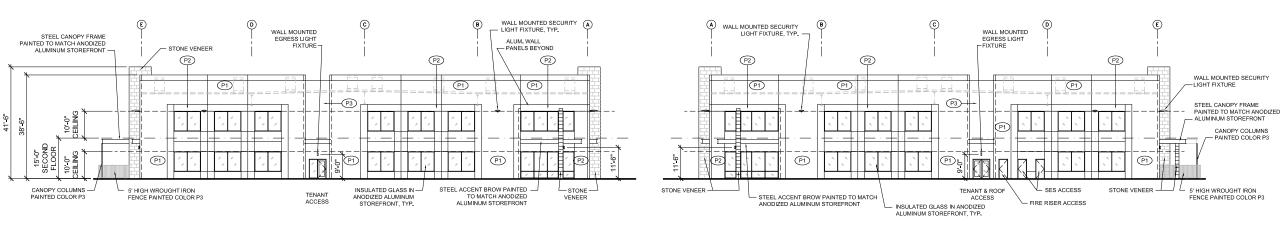

#### **3 EAST ELEVATION**

#### **2 WEST ELEVATION**



2				
A-201.0	PAINT COLOR SCHEDULE:	GLASS:		NOTES:
e   5: \3601/ = olibert spectrum B=5\3601/ A=	P1 DUNN EDWARDS 'WHOLE WHEAT DE 6124  P2 DUNN EDWARDS 'SAND DUNE' DE 6128  P3 DUNN EDWARDS 'ROXY BROWN' DE 6084  ALL COLORS TO BE DUNN EDWARDS PAINTS OR EQUAL	PPG PACIFICA - 1" INSULATED GLASS SOLARBAN 60 (3) U-VALUE OF 0:29 AND SHGC OF 0:25 CLEAR ANODIZED ALUMINUM FRAMES, TYPICAL  STONE VENEER: SEDONA RED FLAGSTONE 16X24" TILE	1. 2. 3. 4.	CONCRETE TILT PANELS TO RECEIVE A SMOOTH UNIFORM FINISH, U.N.O.  PAINT COLORS SUBJECT TO CHANGE, NO COLOR SHALL HAVE A LIGHT REFLECTIVE VALUE (LRV) GREATER THAN 79.  ALL SIGNAGE REQUIRES SEPARATE REVIEW AND PERMIT PROCESS, EXCEPT ADDRESS NUMBERS.  ALL ROOF MOUNTED MECHANICAL EQUIPMENT SHALL BE FULLY SCREENED BY PARAPET WALLS EQUAL TO, OR GREATER THAN, THE HIGHEST POINT ON THE MECHANICAL EQUIPMEN SOLID MASONRY WALLS AND GATES EQUAL TO, OR GREATER THAN, THE HIGHEST POINT ON THE MECHANICAL EQUIPMENT SHALL SCREEN ALL GROUND MOUNTED MECHANICAL.
ещаке				EQUIPMENT.

# **4 SOUTH ELEVATION**



DEVELOPER:







PROJECT TITLE:

**GILBERT SPECTRUM BUILDING 5** 

**DESIGN REVIEW** 

Issue Date:	10.17.201
Scale:	1/16" = 1'-0
Drawn By:	Е
DEVISIONS:	

PRAWING TITLE:


EXTERIOR ELEVATIONS

**EXHIBIT 8** 

A-201

COPYRIGHT ©



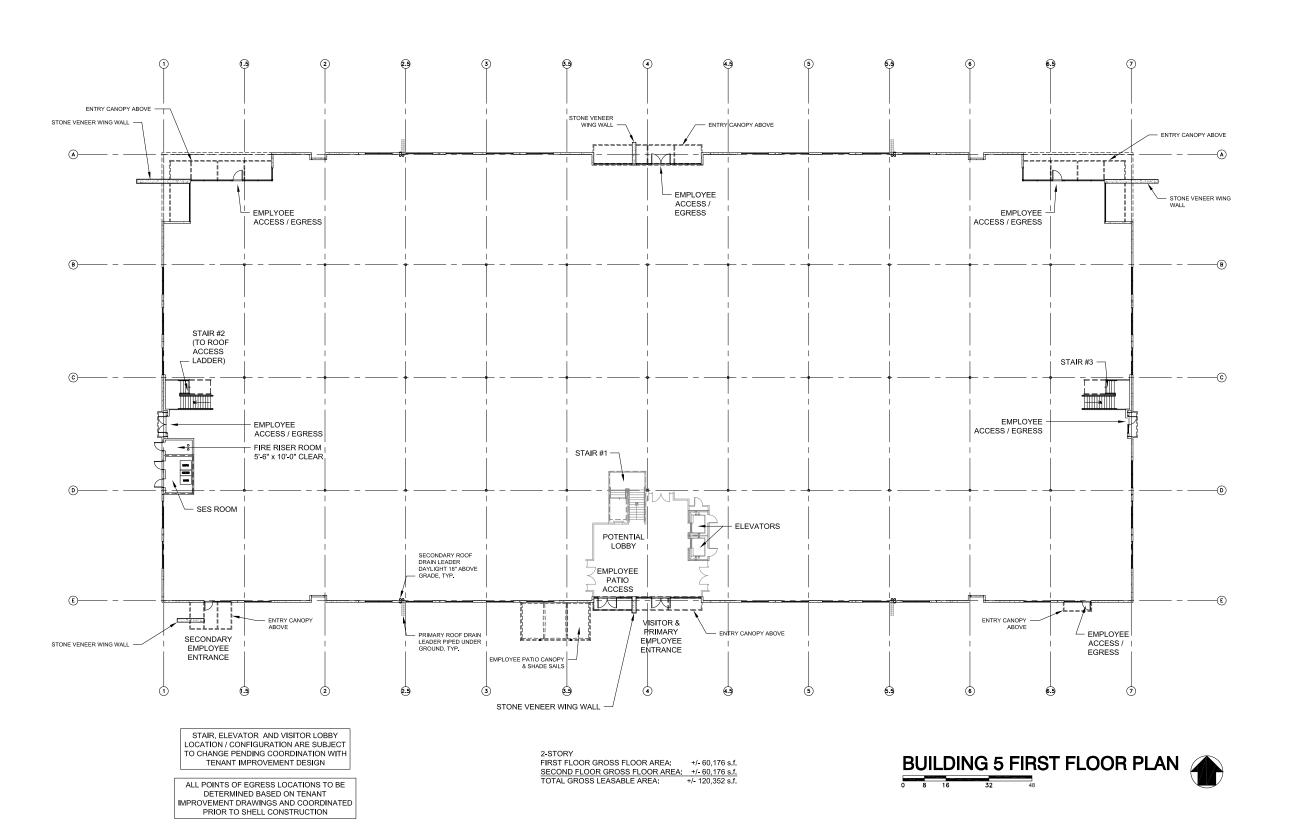



DESIGNER:





GRAYCOR

# Date: Description:

PROJECT TITLE:

GILBERT SPECTRUM

BUILDING 5
DESIGN REVIEW

Issue Date: 10.17.2019
Scale: 1/16" = 1'-0"
Drawn By: EF
REVISIONS:

DRAWING TITLE:


FLOOR PLAN

**EXHIBIT 9A** 

DRAWING NUM

A-102

PYRIGHT ©

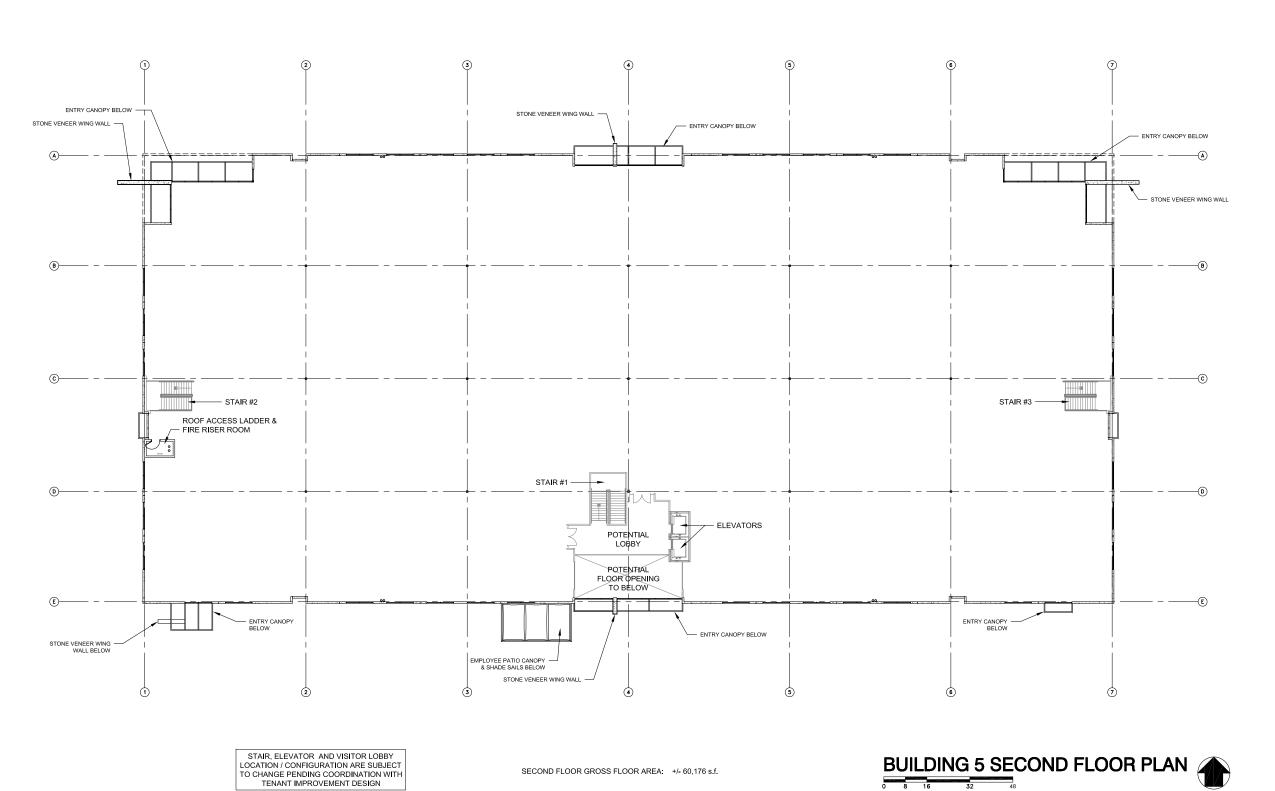

DEVELOPER:



DESIGNE





GRAYCOR Construction Company Inc.

# Date: Description:

PROJECT TITLE:

GILBERT SPECTRUM

**BUILDING 5** 

DESIGN REVIEW

Issue Date:	10.17.2019
Scale:	1/16" = 1'-0'
Drawn By:	EF
REVISIONS:	

DRAWING TITLE:

FLOOR PLAN

EXHIBIT 9B


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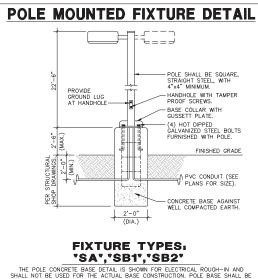
A-103


OPYRIGHT @


chedule											
Symbol	Label	Quantity	Manufactur er	Catalog Number	Description	Lamp	Number Lamps	Filename	Lumens Per Lamp	Light Loss Factor	Wattage
	SA	2	Lithonia Lighting	40K T3M MVOLT	DSX1 LED P8 40K T3M MVOLT with houseside shield	LED	1	DSX1_LED_P 8_40K_T3M_ MVOLT_HS.i es	19090	0.91	207
	SB1	3	Lithonia Lighting		DSX1 LED P8 40K T5W MVOLT	LED	1	DSX1_LED_P 8_40K_T5W_ MVOLT.ies	25014	0.91	207
- -	SB2	10	Lithonia Lighting	DSX1 LED P5 40K T5W MVOLT/ SSS 22.5' POLE ON A 2.5' BASE	DSX1 LED P5 40K T5W MVOLT	LED	1	DSX1_LED_P 5_40K_T5W_ MVOLT.ies	16327	0.91	276
	sc	3	Lithonia Lighting		DSX1 LED P9 40K TFTM MVOLT	LED	1	DSX1_LED_P 9_40K_TFTM _MVOLT.ies	27578	0.91	241
0	SD	9	V2 LIGHTING	C3LS N V W 10 83 40 60 (FINISH)	WALL MOUNT CYLINDER	"Xicato XTM1983XX20C CA-typical module at 70C, 350mA"	1	CORE QUBE TILT_83CRI_ 1000lm_60 degree.IES	965	0.91	6.6
	SW1	8	Lithonia Lighting	MVOLT	DSXW2 LED WITH 3 LIGHT ENGINES, 30 LED's, 1000mA DRIVER, 4000K LED, TYPE 3 MEDIUM OPTIC	LED	1	DSXW2_LED _30C_1000_ 40K_T3M_M VOLT.ies	11279	0.91	109

Statistics							
Description	Symbol	Avg	Max	Min	Max/Min	Avg/Min	
FC ON SITE AT GRADE	+	1.5 fc	8.9 fc	0.0 fc	N/A	N/A	
PROP LINE	+	0.2 fc	0.5 fc	0.0 fc	N/A	N/A	



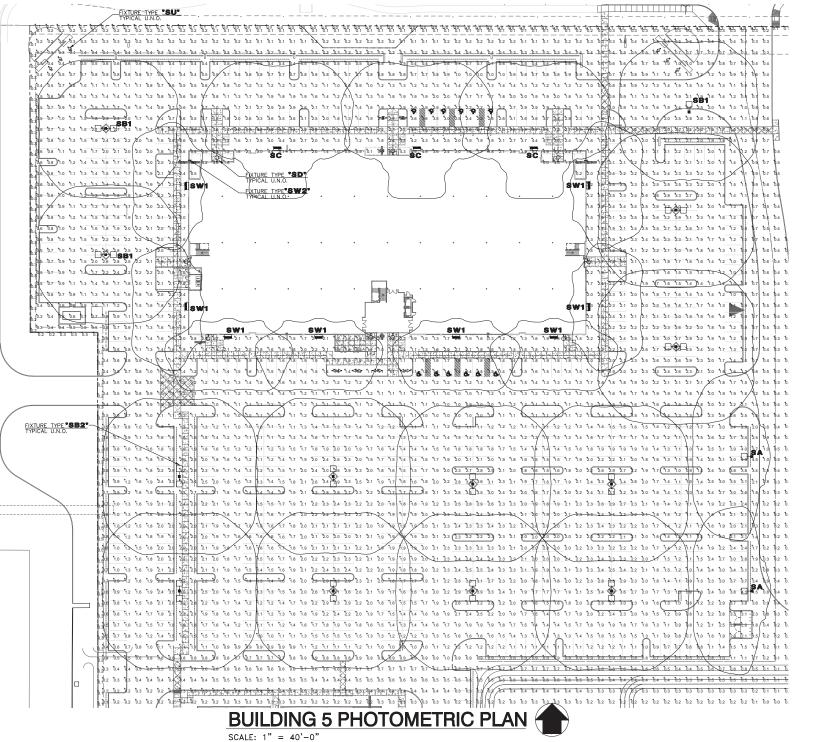

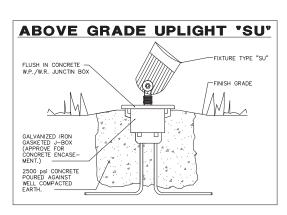

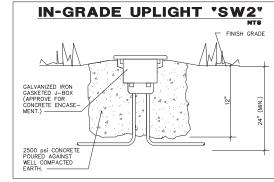


**PRELIMINARY** 

NOT FOR CONSTRUCTION

IF DRAWING IS NOT PLOTTED AT  $24 \times 36$  They are not full size

Project # 19331 HAWKINS DESIGN GROUP INC.

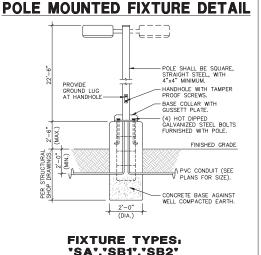

BALMER

✓ SunCap PROPERTY GROUP






**GILBERT SPECTRUM BUILDING 5** 


**DESIGN REVIEW** 

Issue Date:	10.17.2019
Scale:	
Drawn By:	EF
REVISIONS:	


**ELECTRICAL** SITE PHOTOMETRIC

**DR100 EXHIBIT 10A** 

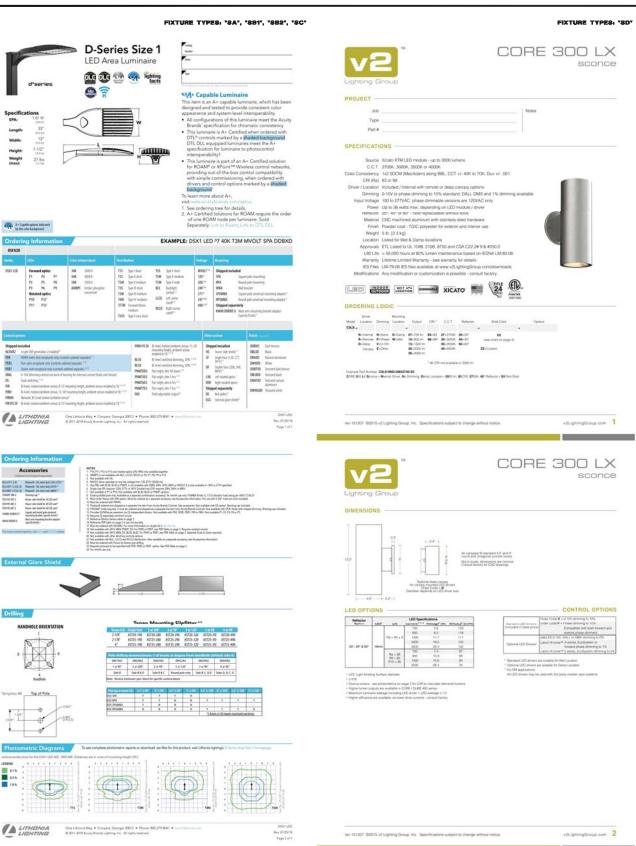

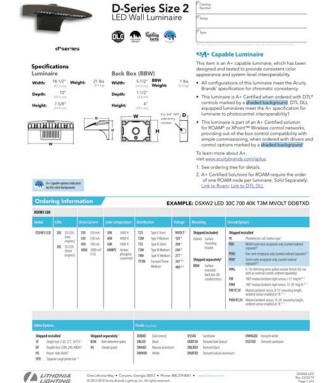

FIXTURE TYPES: 'SW1'

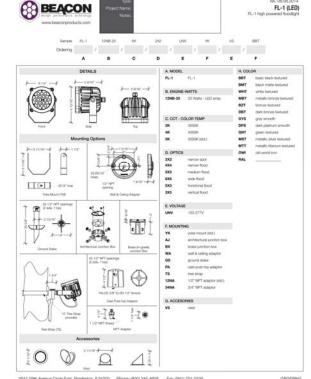



Spot (SP) Narrow Flood (NF) Wall Wash (WW)





IF DRAWING IS NOT PLOTTED AT 24 x 36 THEY ARE NOT FULL SIZE

1 (LED) Roodight

FIXTURE TYPES, 'SU'

DEVELOPER:



IGNER:







# Date: Description:

PROJECT TITLE:

Scale:

Drawn Bv:

REVISIONS:

DRAWING TITLE:

ELECTRICAL

**CUT SHEETS** 

GILBERT SPECTRUM

DESIGN REVIEW

**BUILDING 5** 

Issue Date: 10.17.2019

EF

DRIVE-OVER DURABILITY: When installed in concrete, fixture will withstand drive-over by whiches weighting on to 10,000 B.

CATION: (UL1598, UL8750),

> DR200 EXHIBIT 10B

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